


APPENDIX B


FACILITY LOCATION MAPS


(PART 4 OF 4)

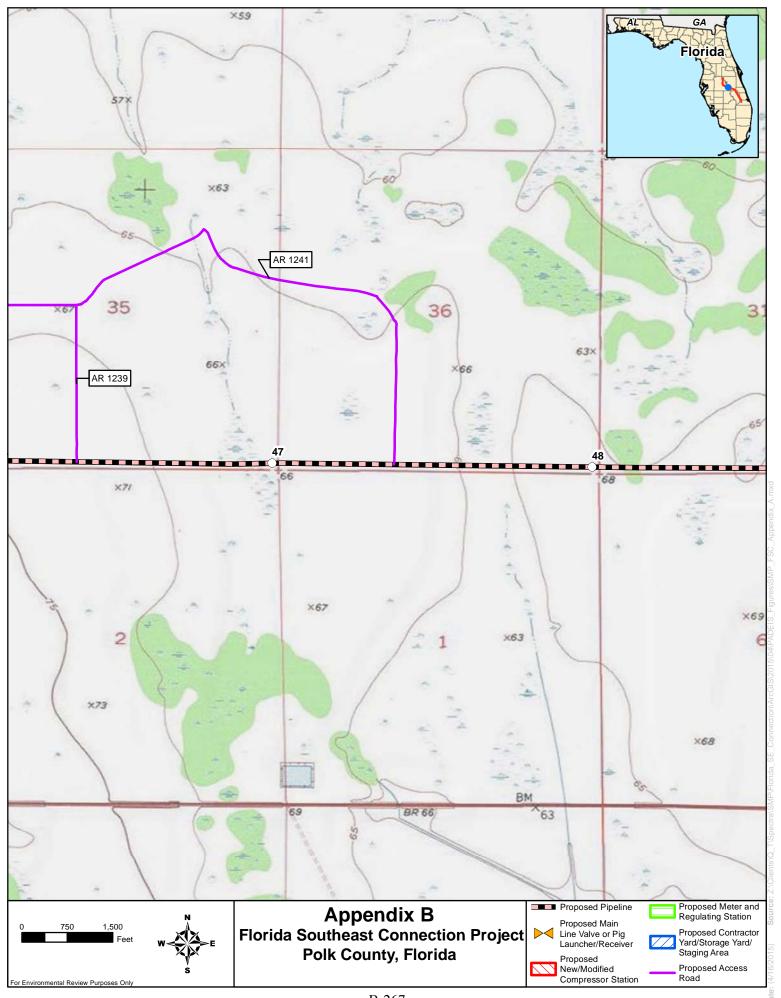


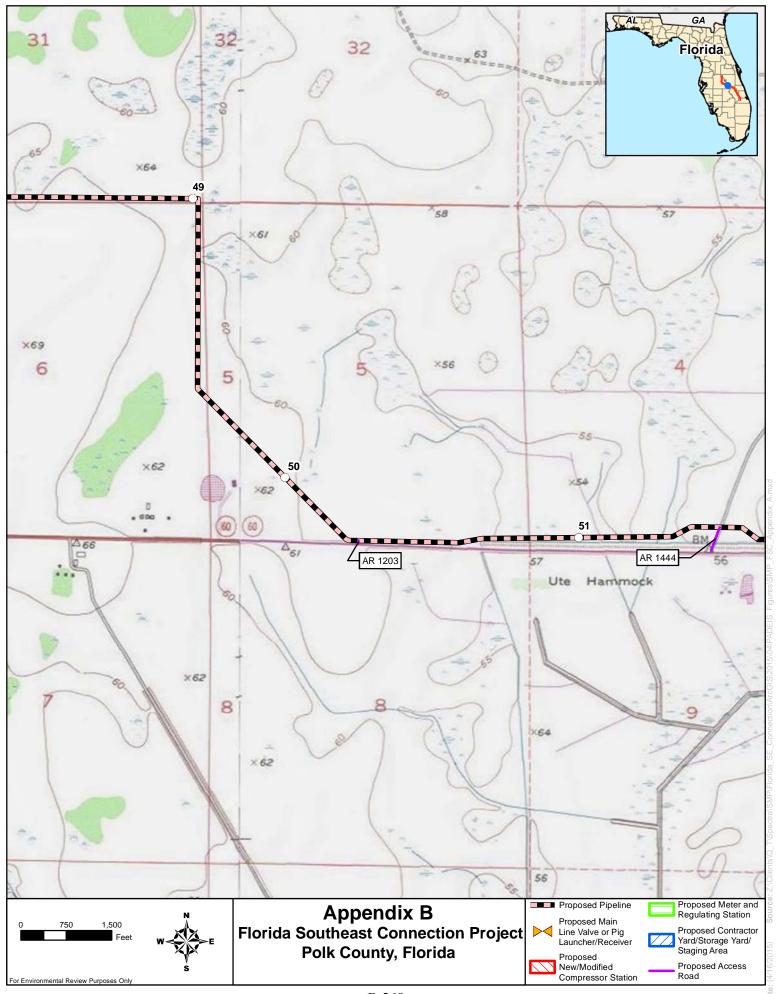


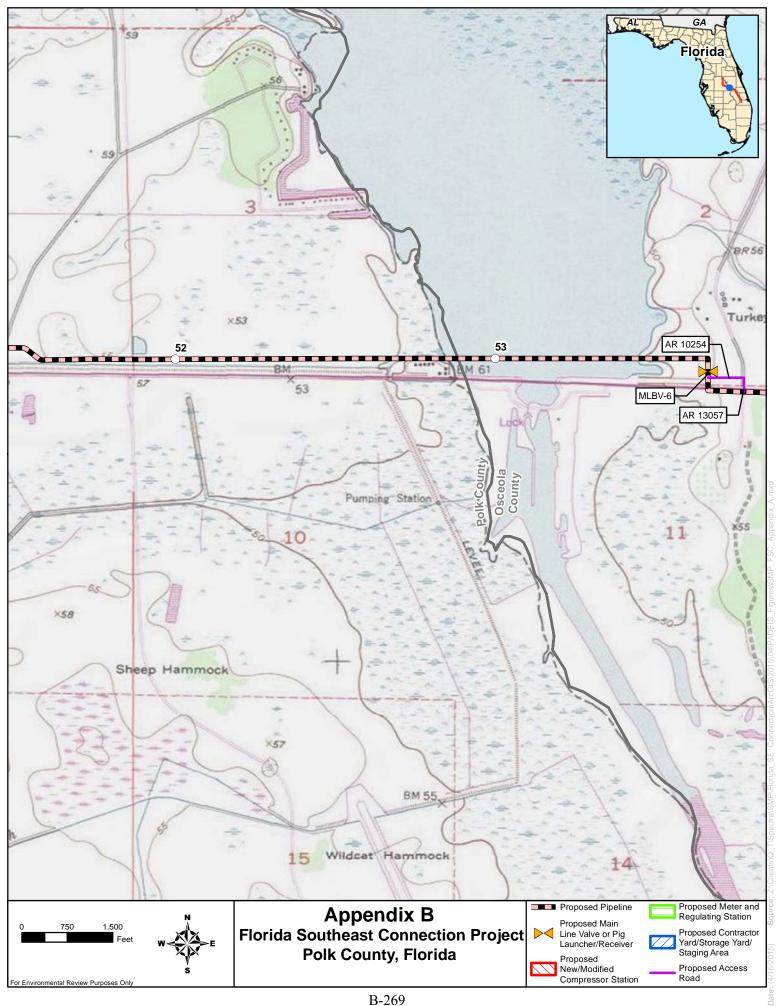


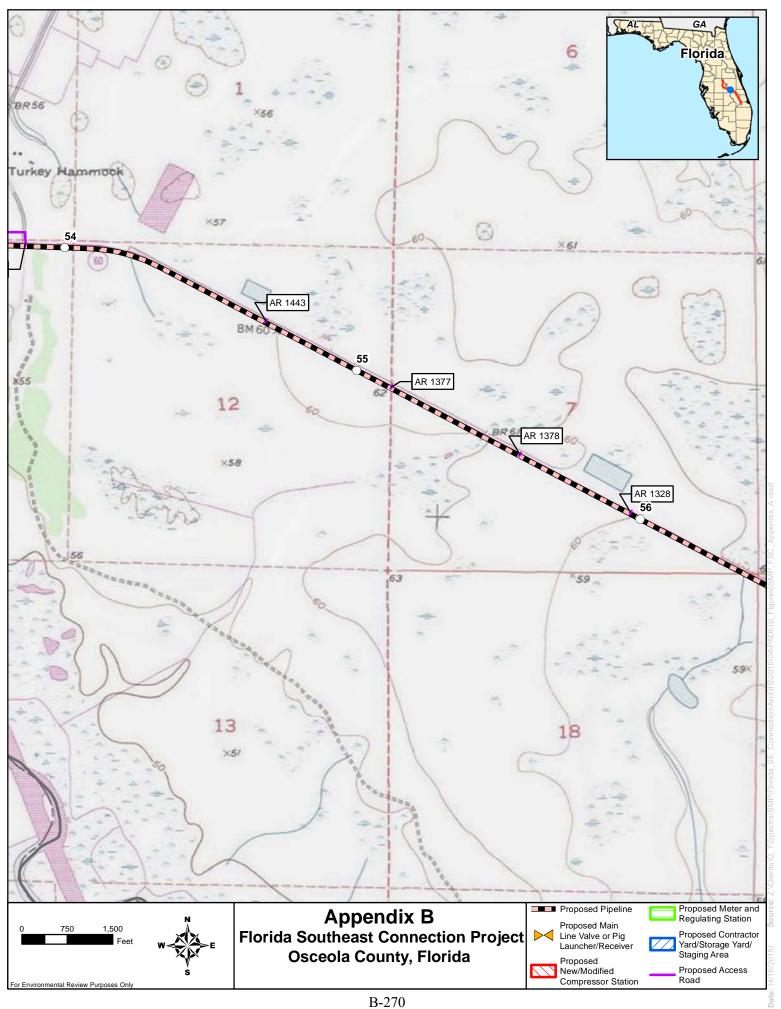


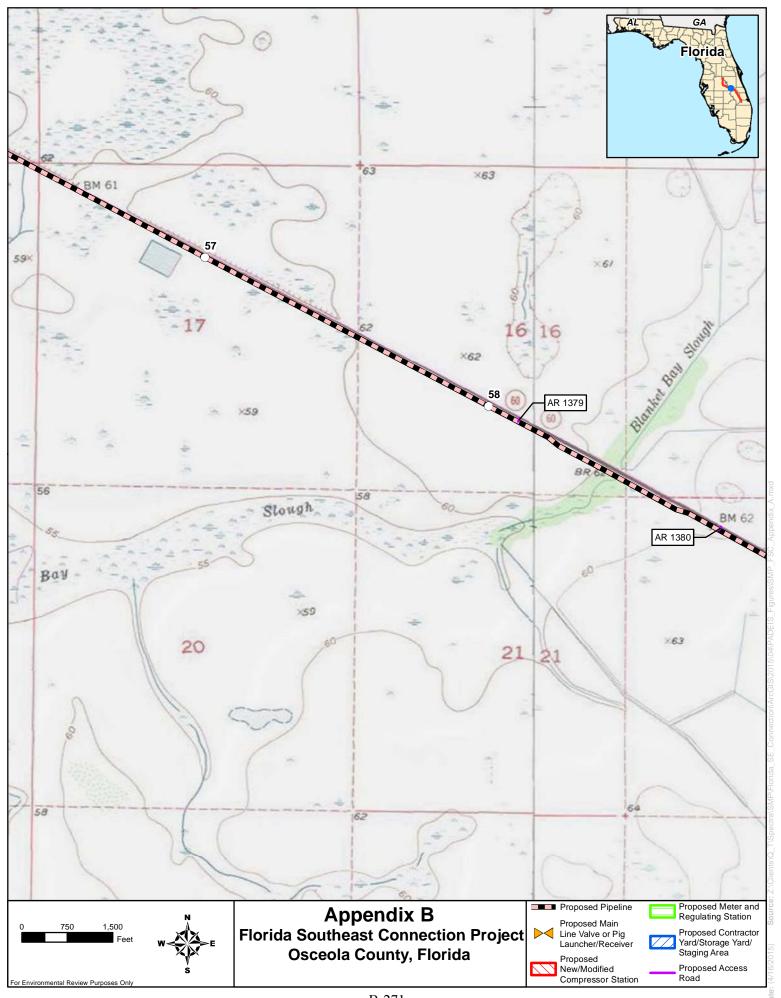


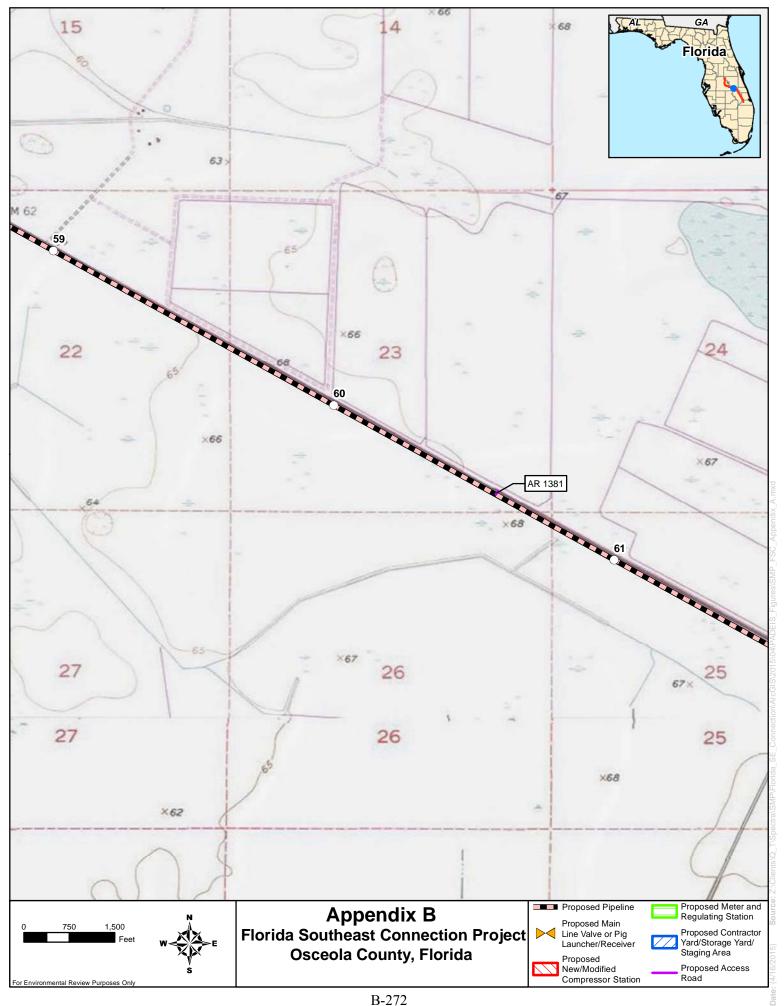


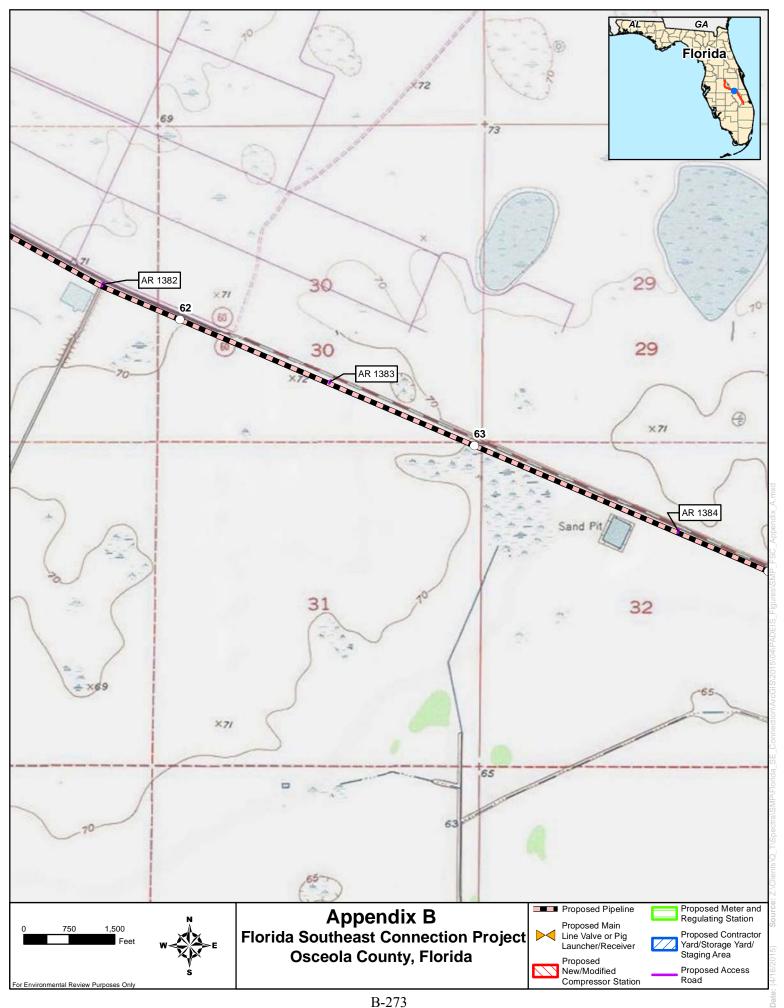


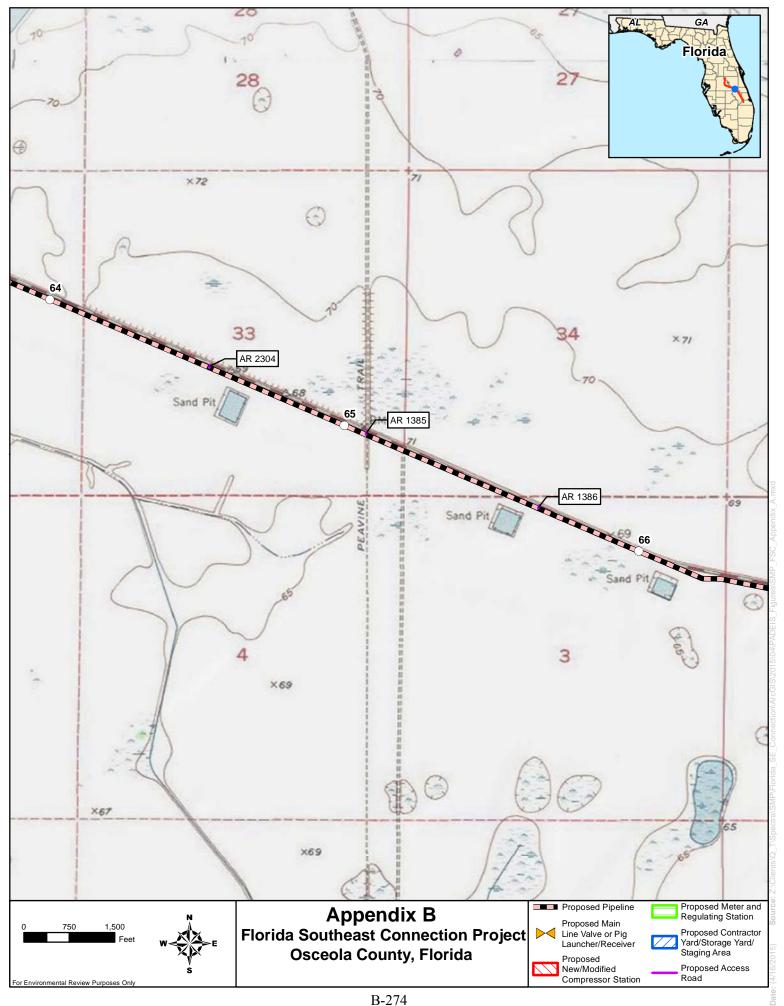


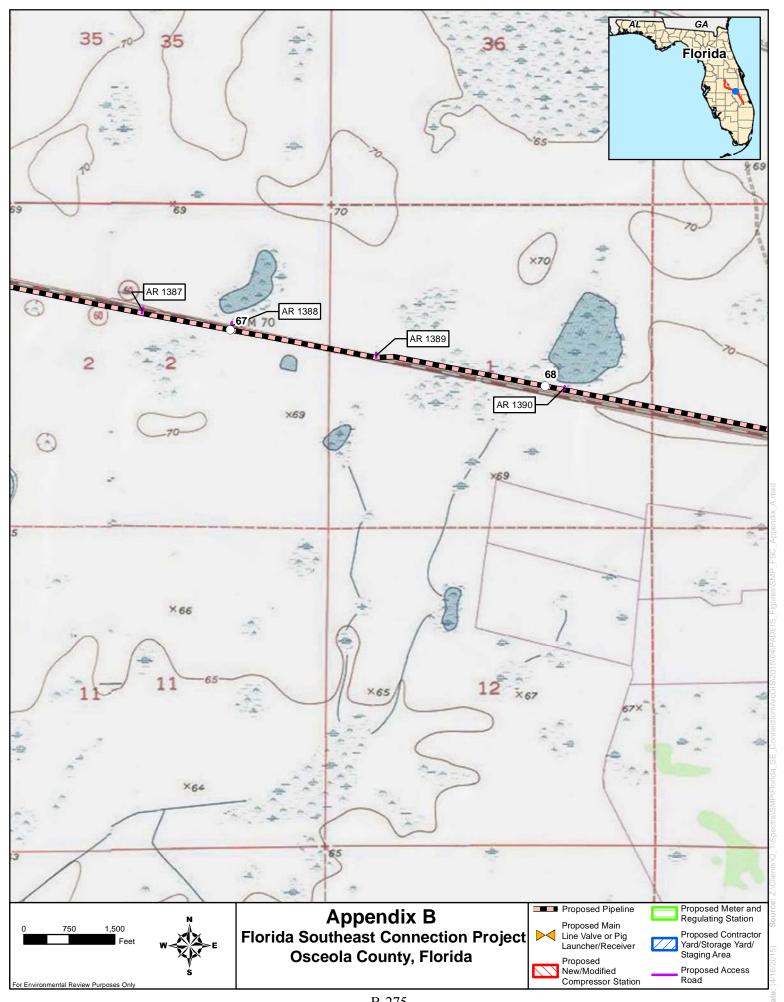


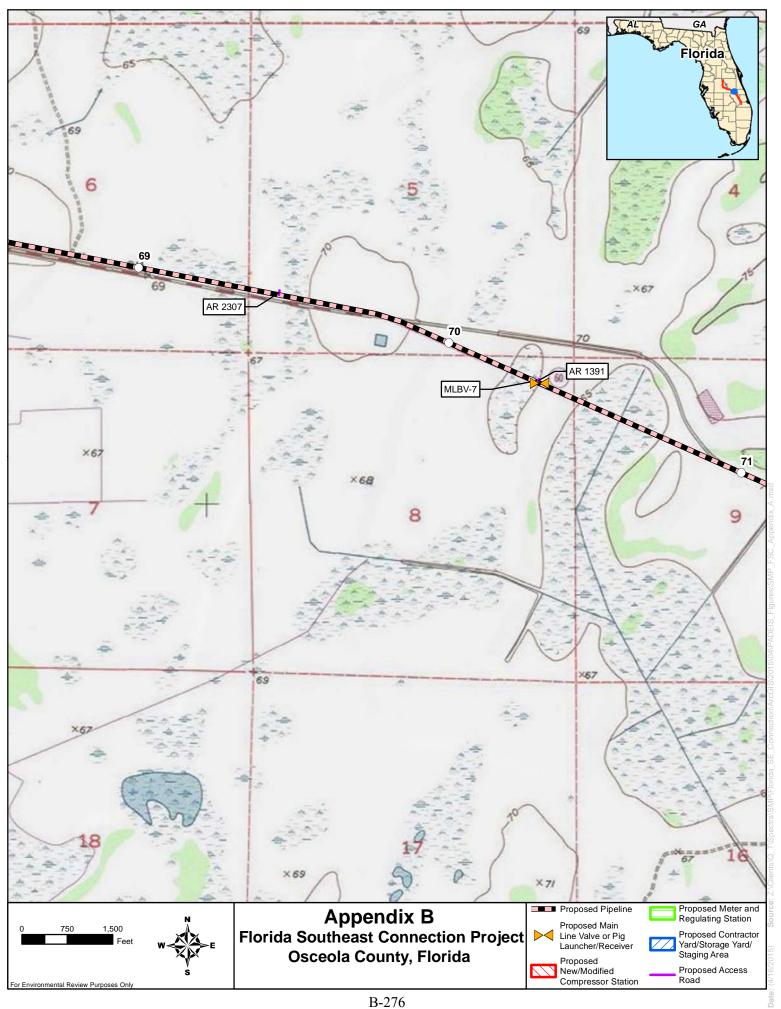


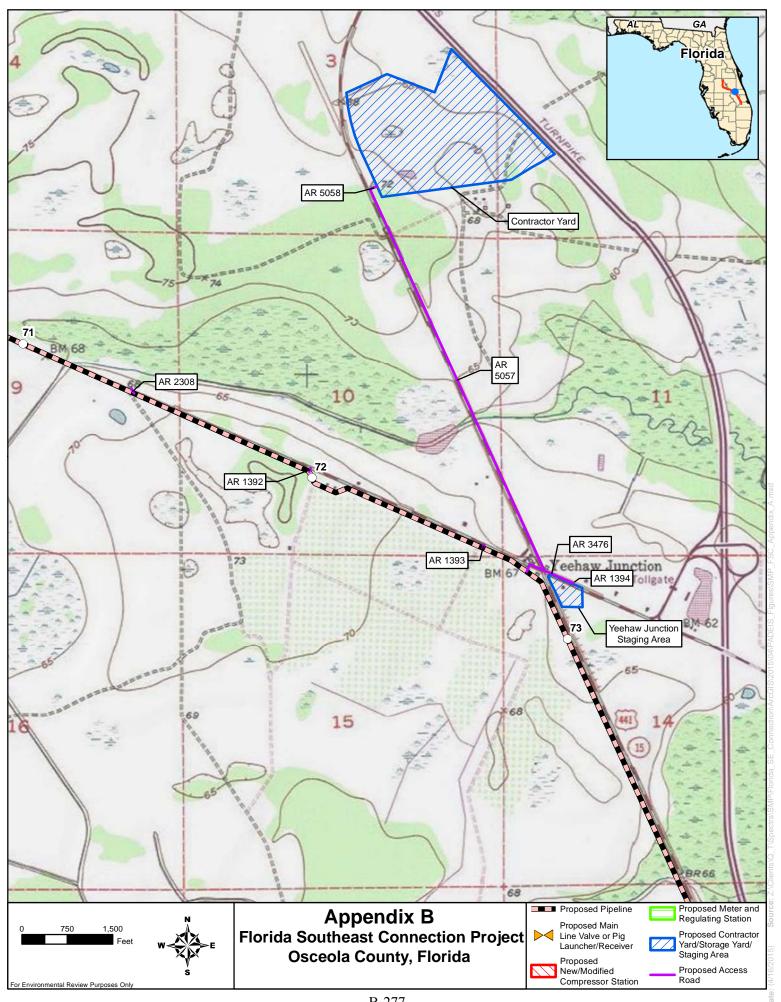


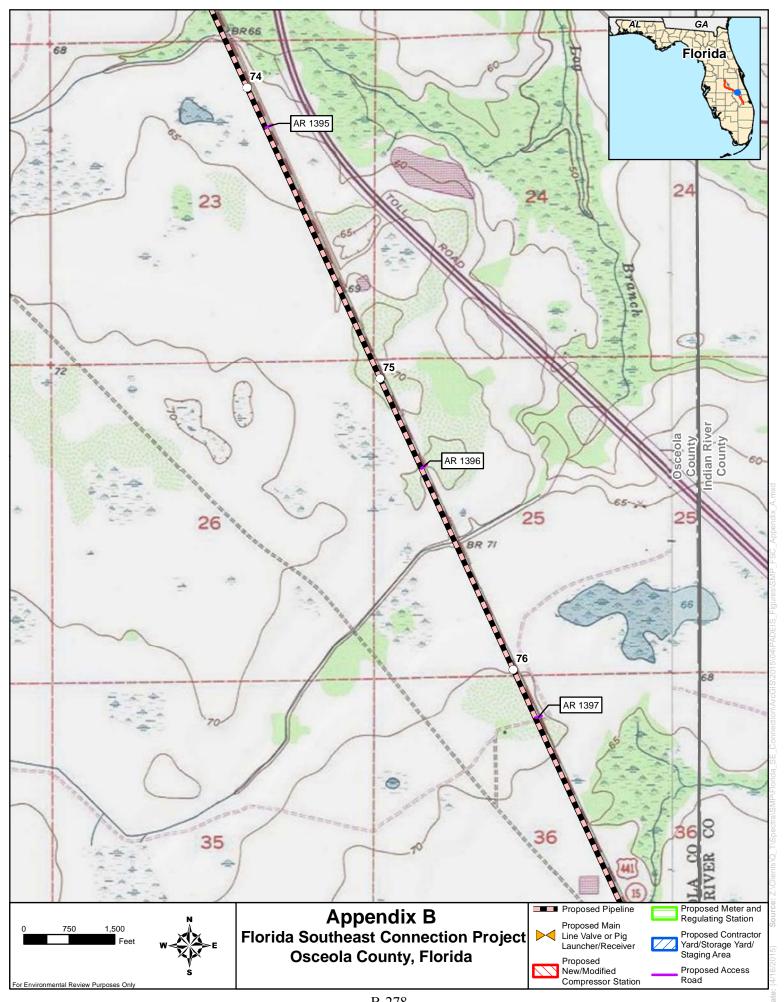


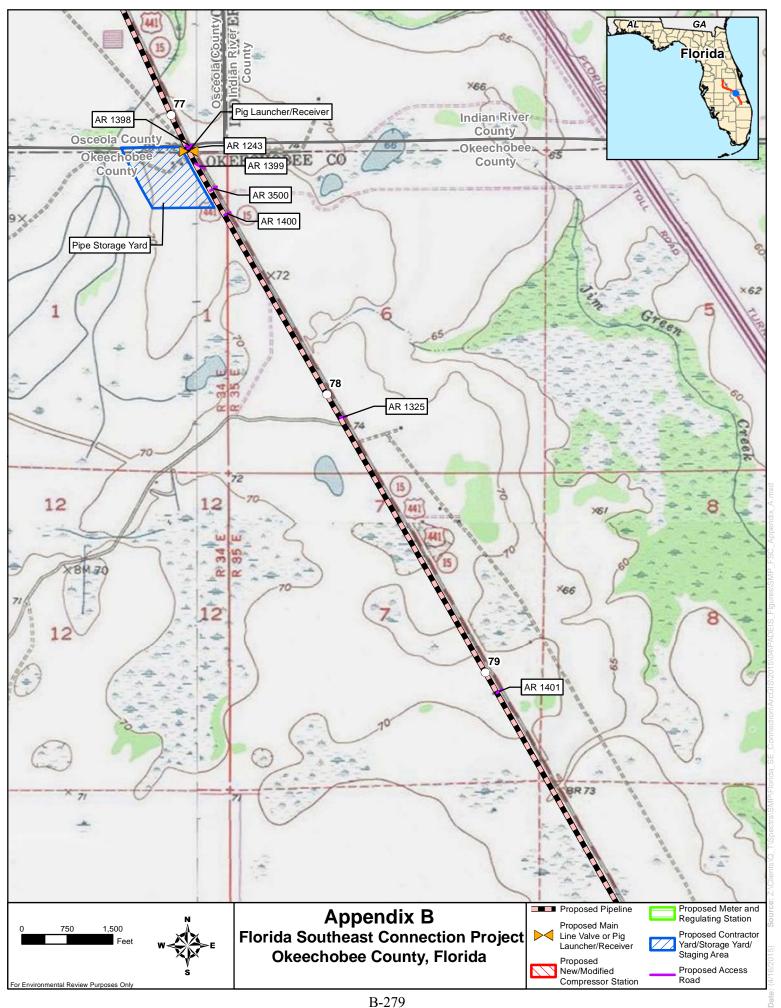


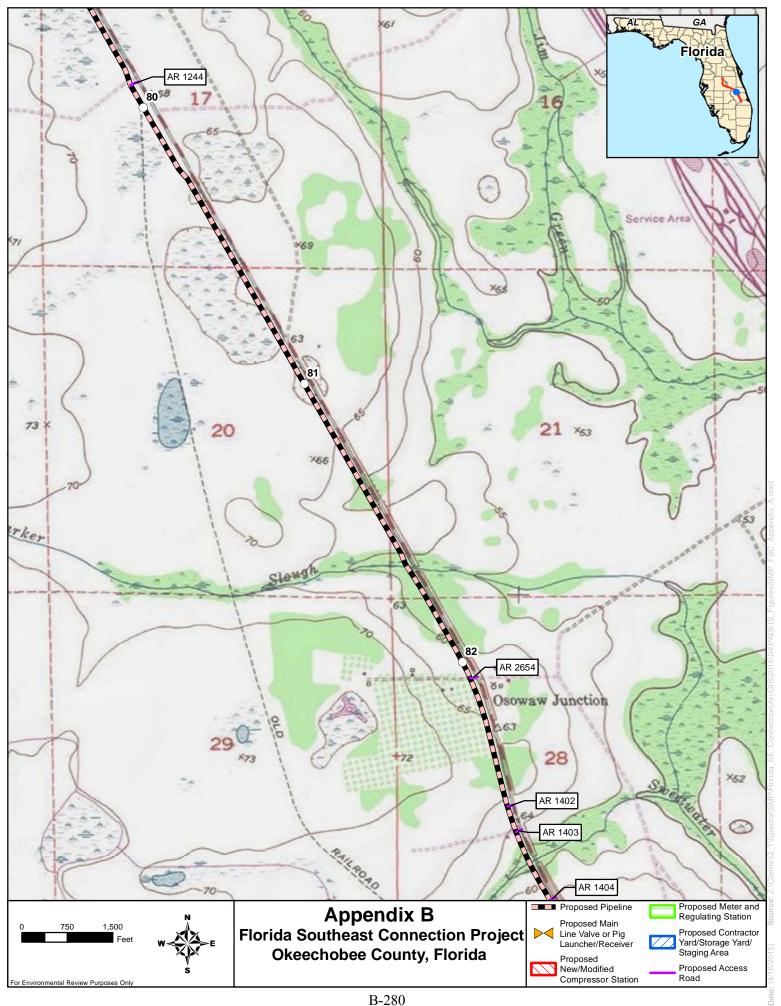


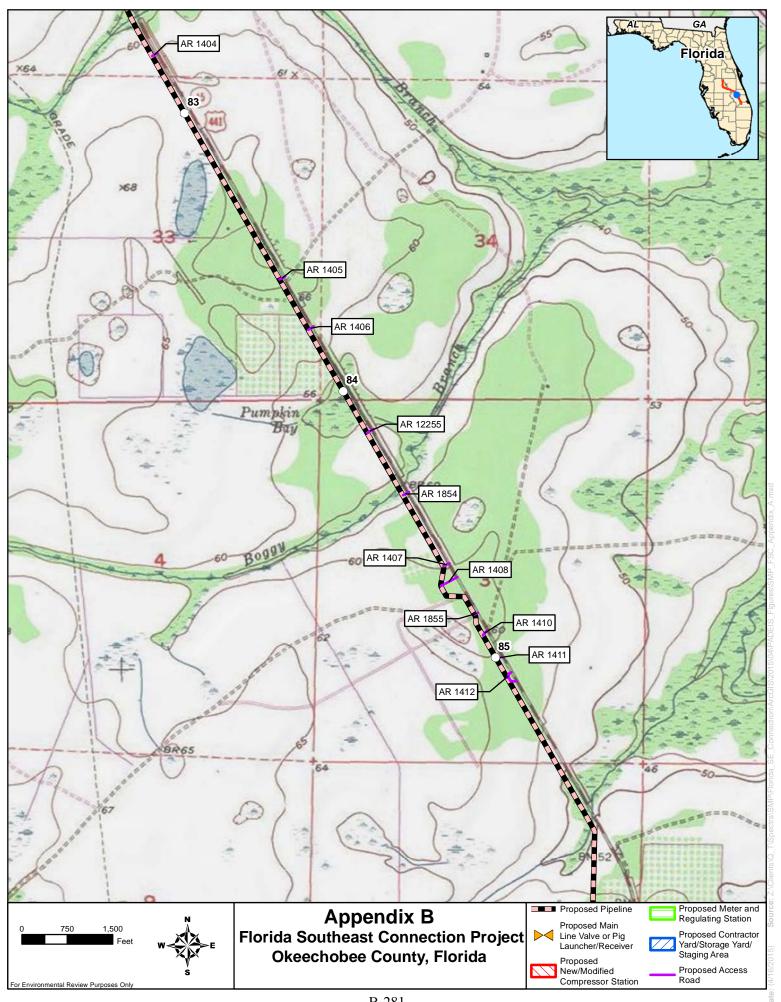


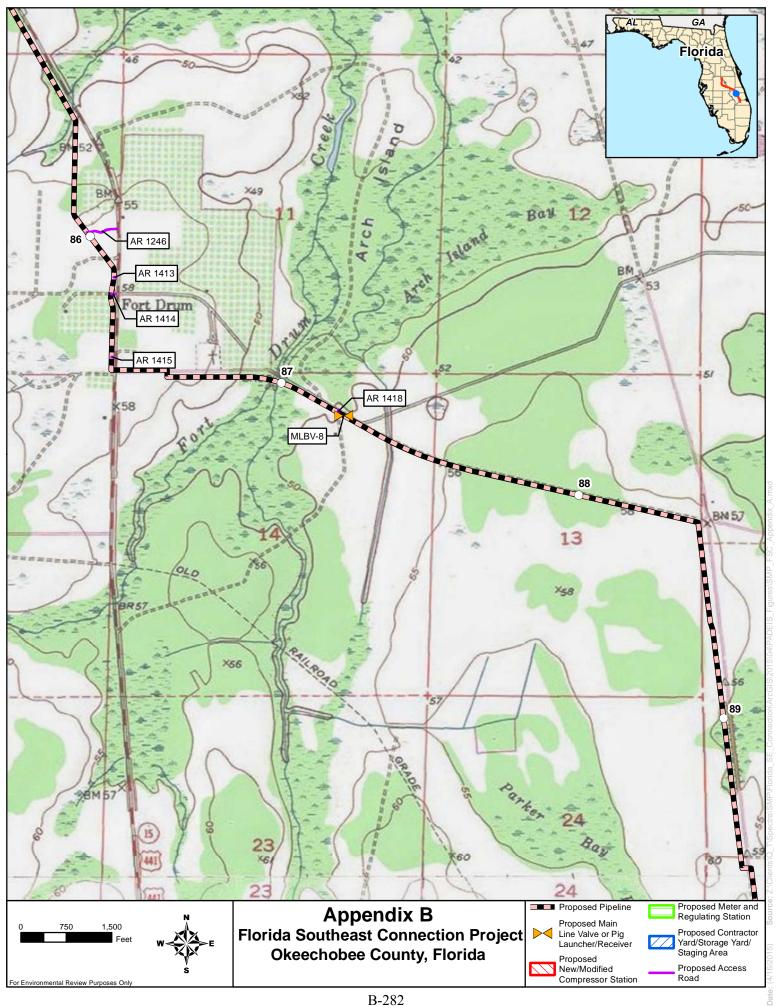


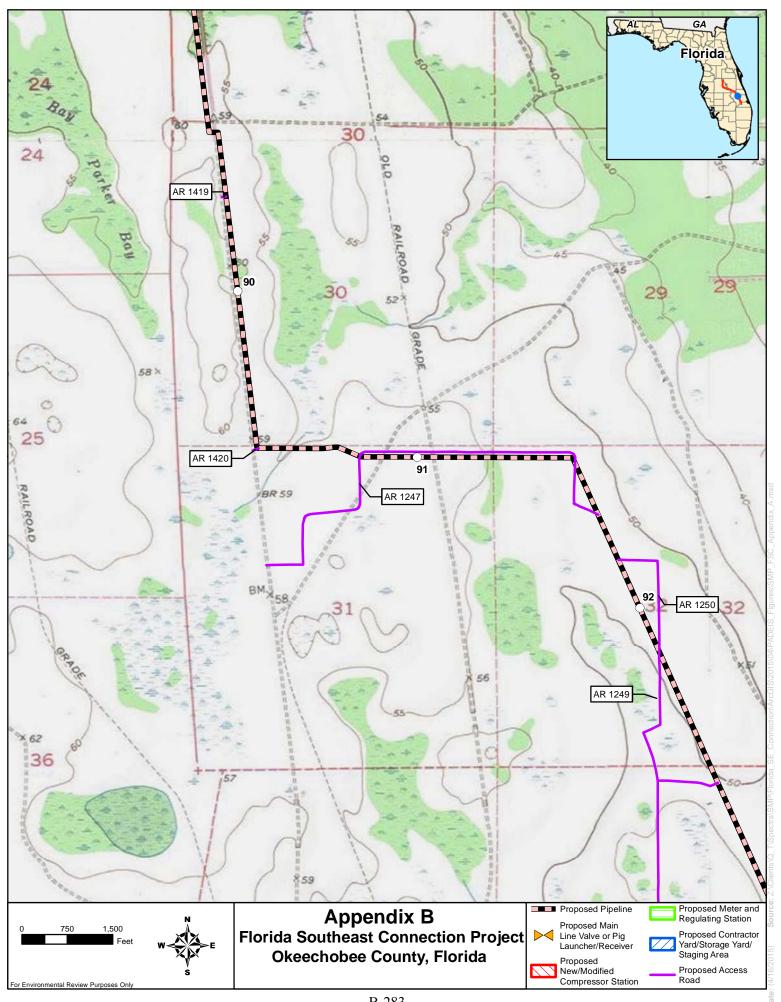

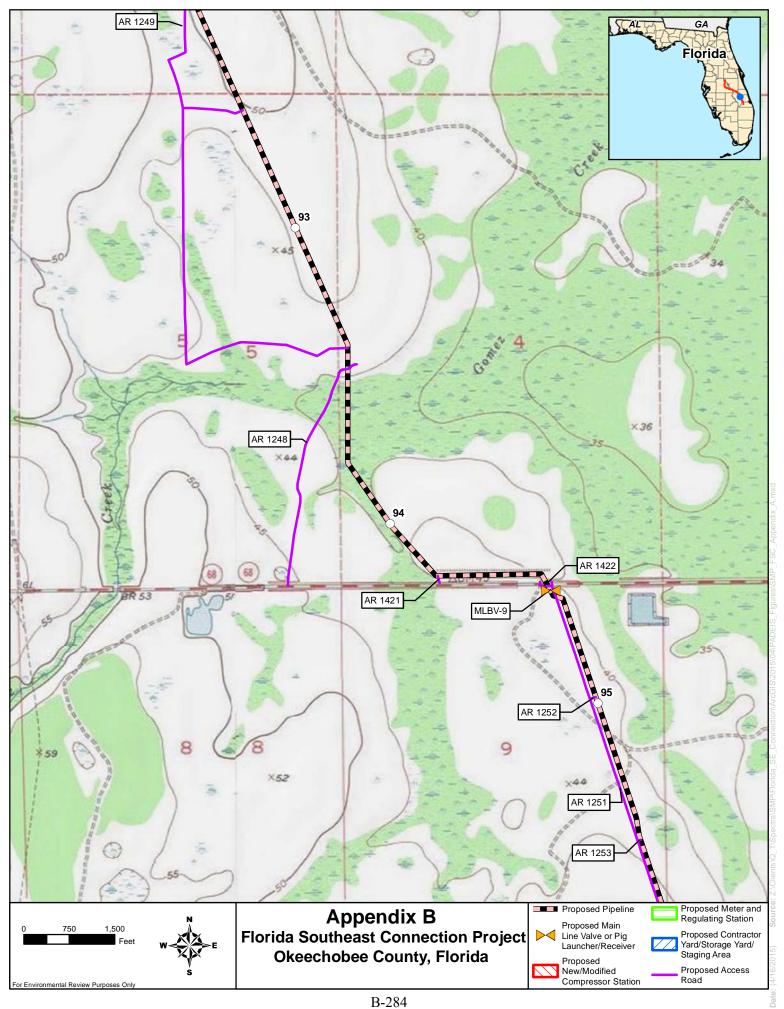


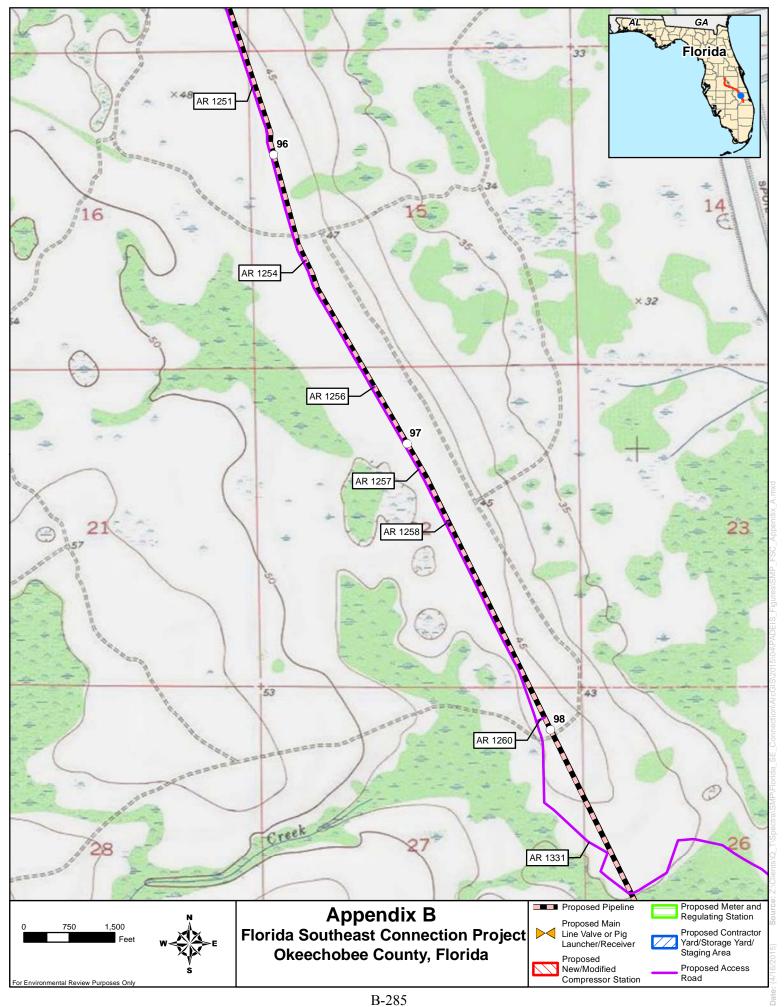


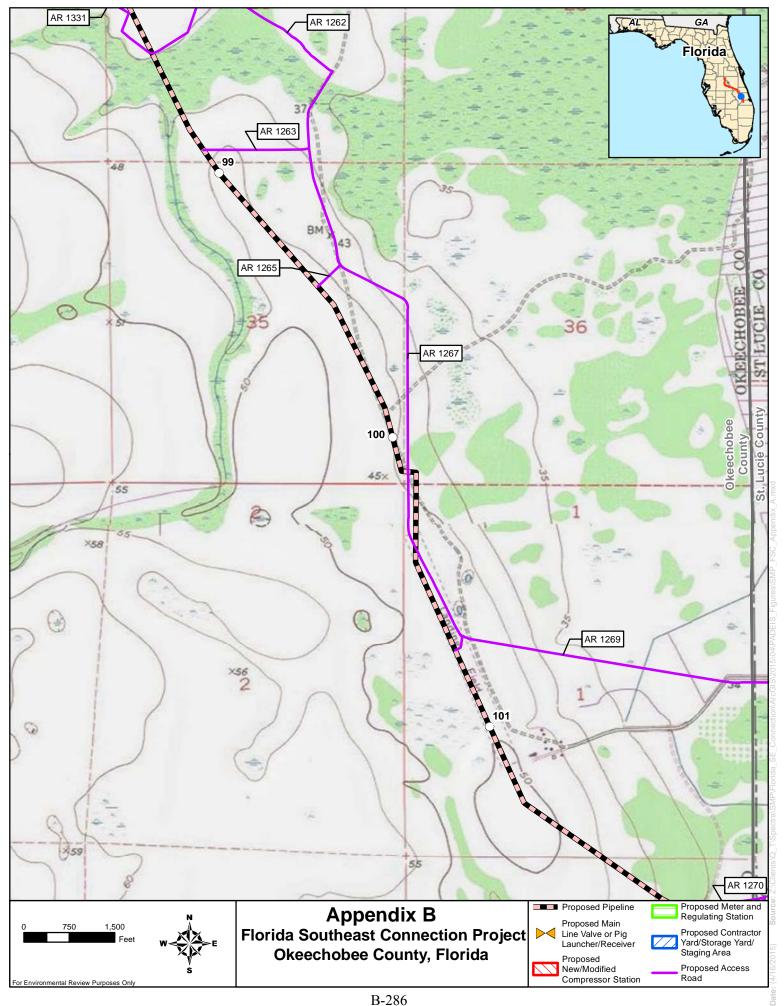


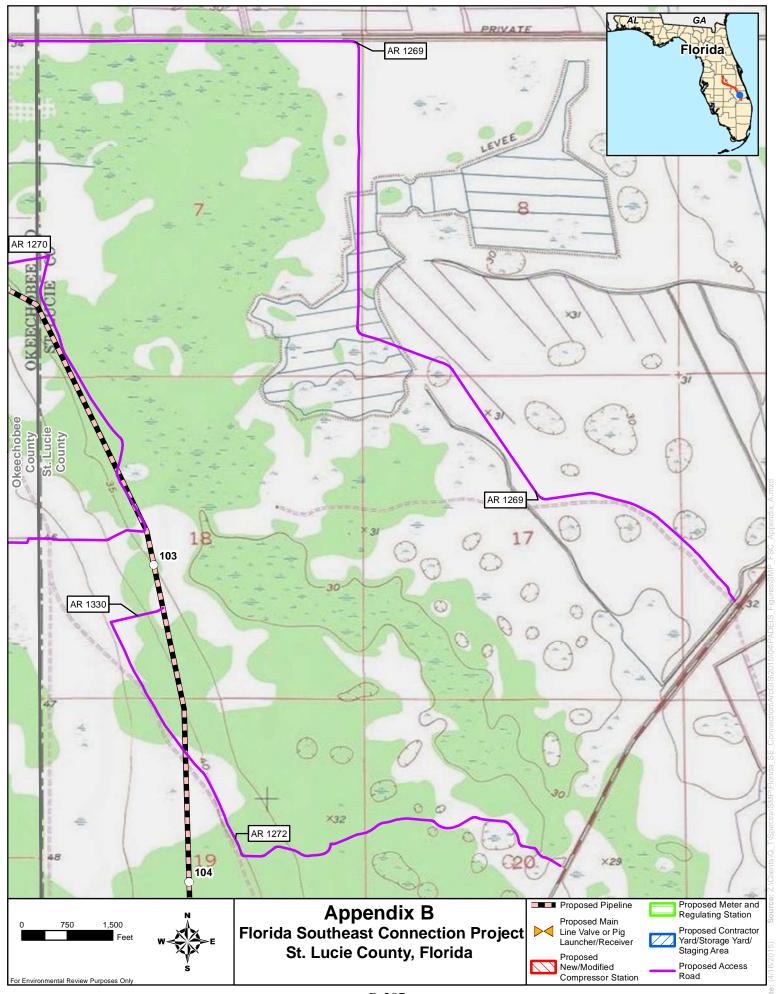





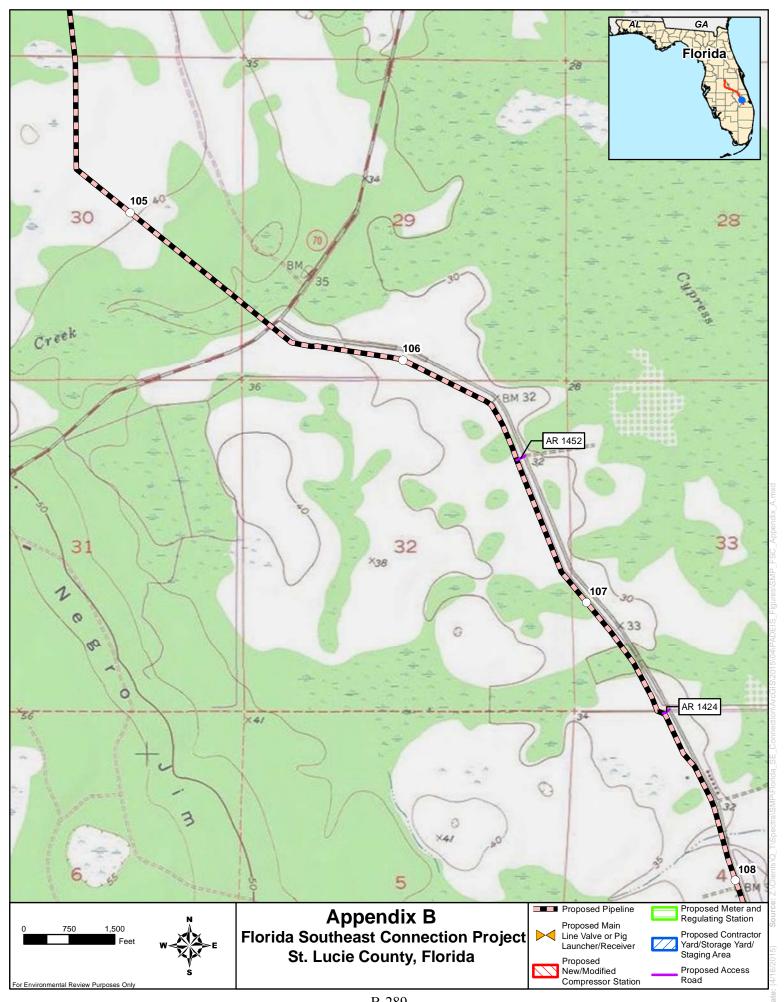


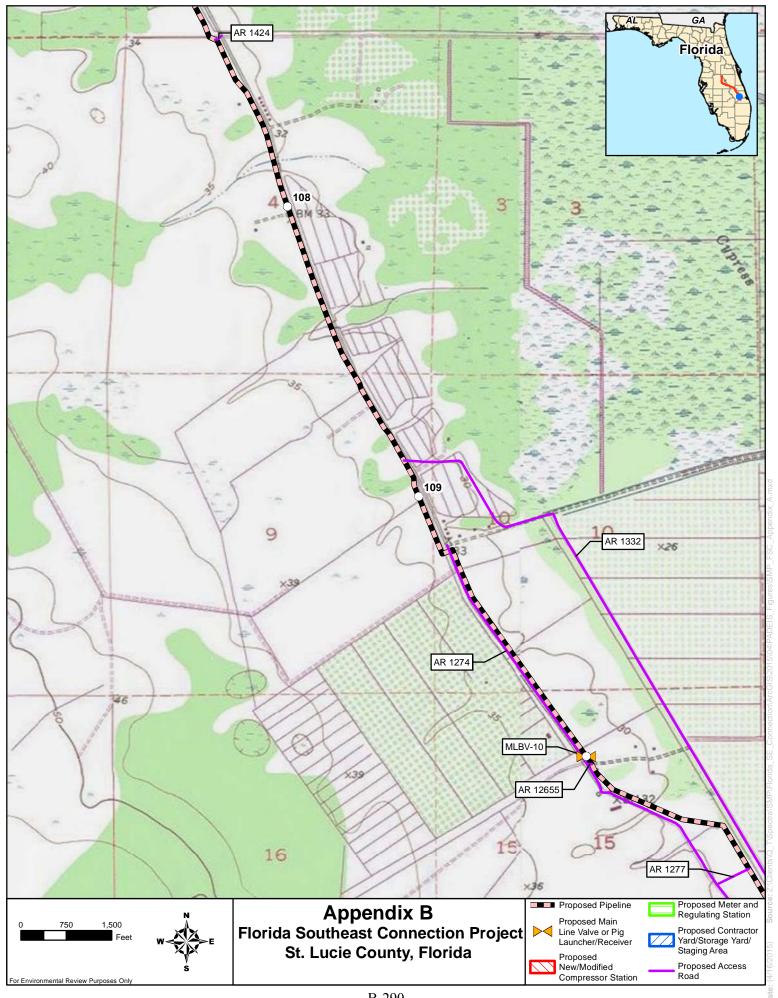


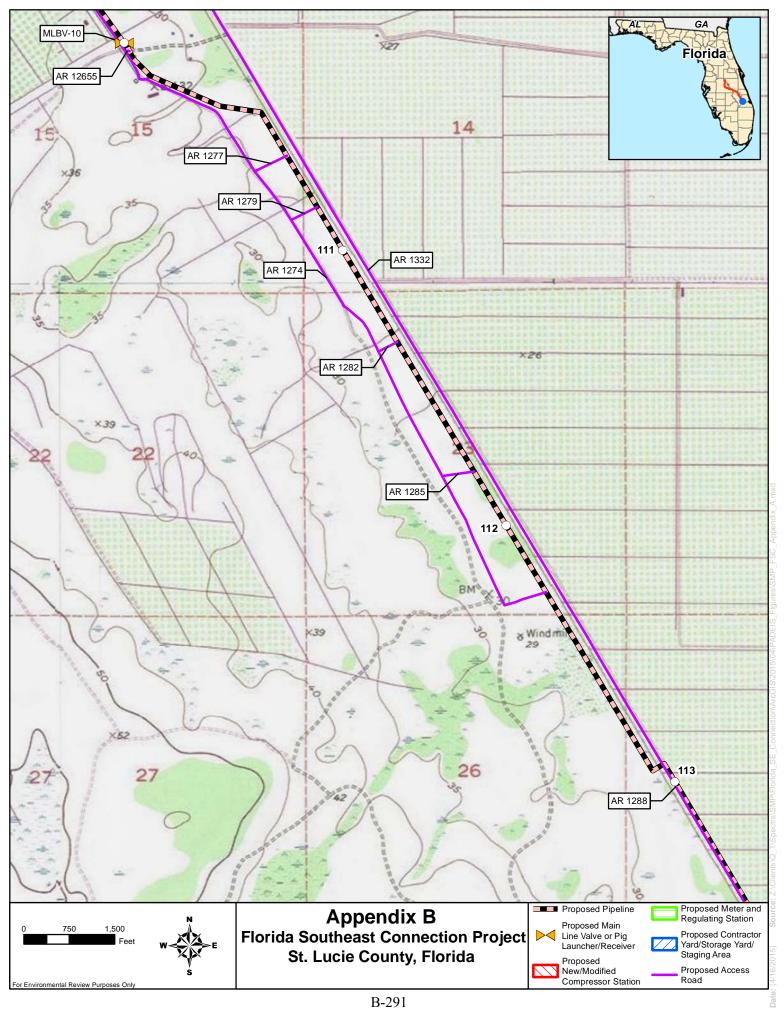


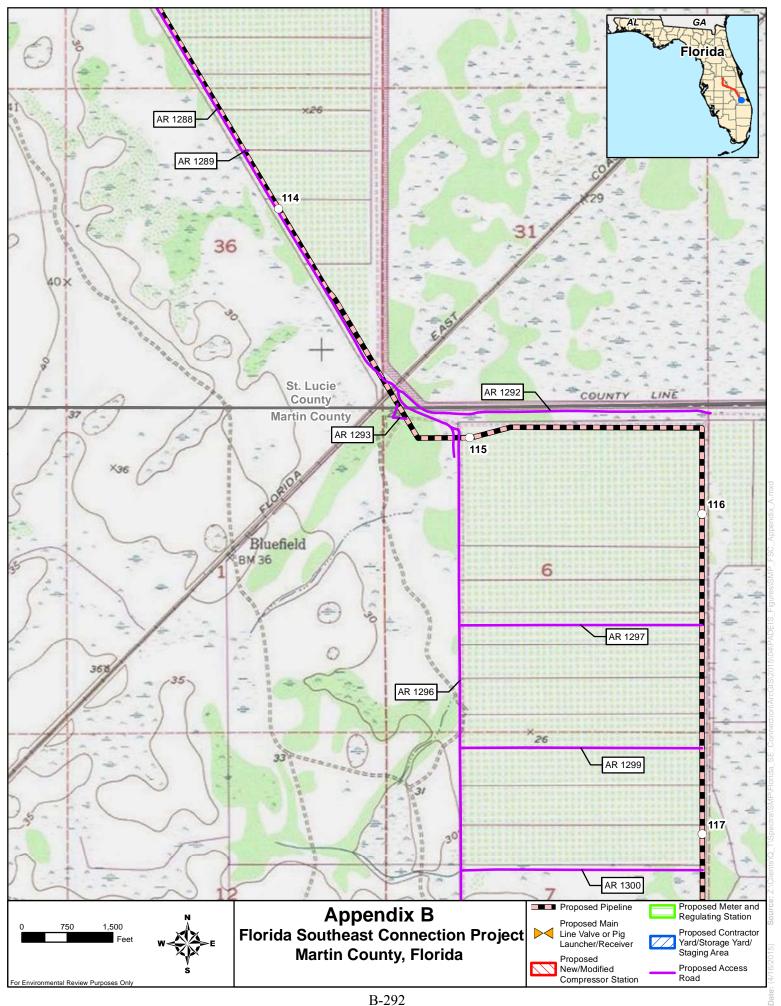

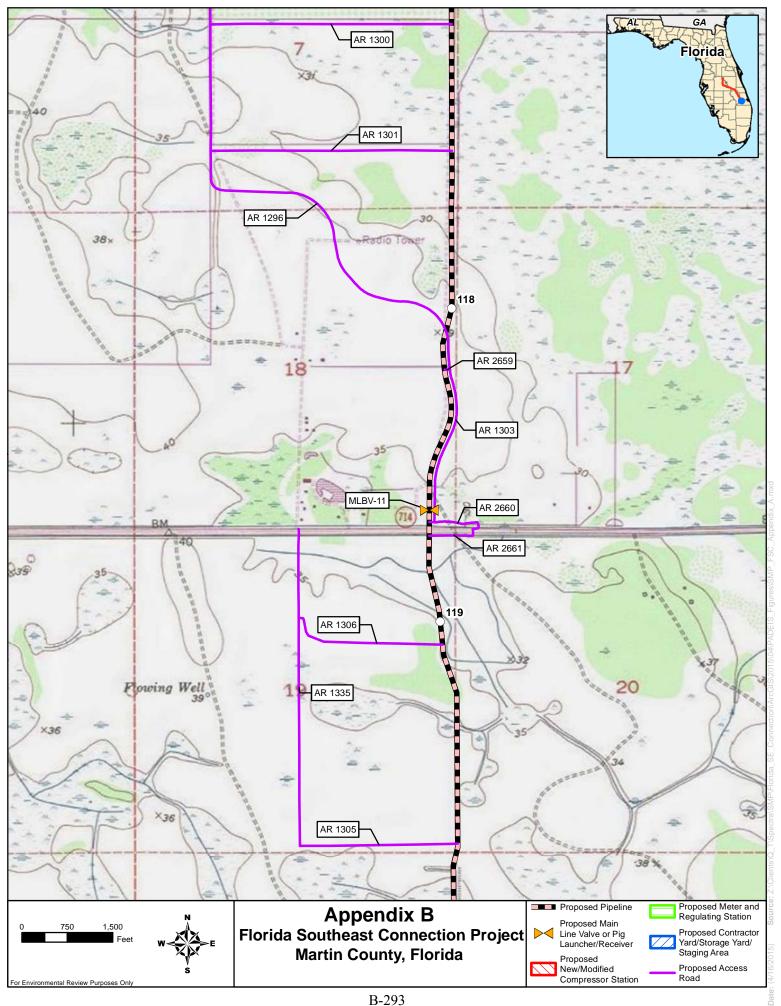

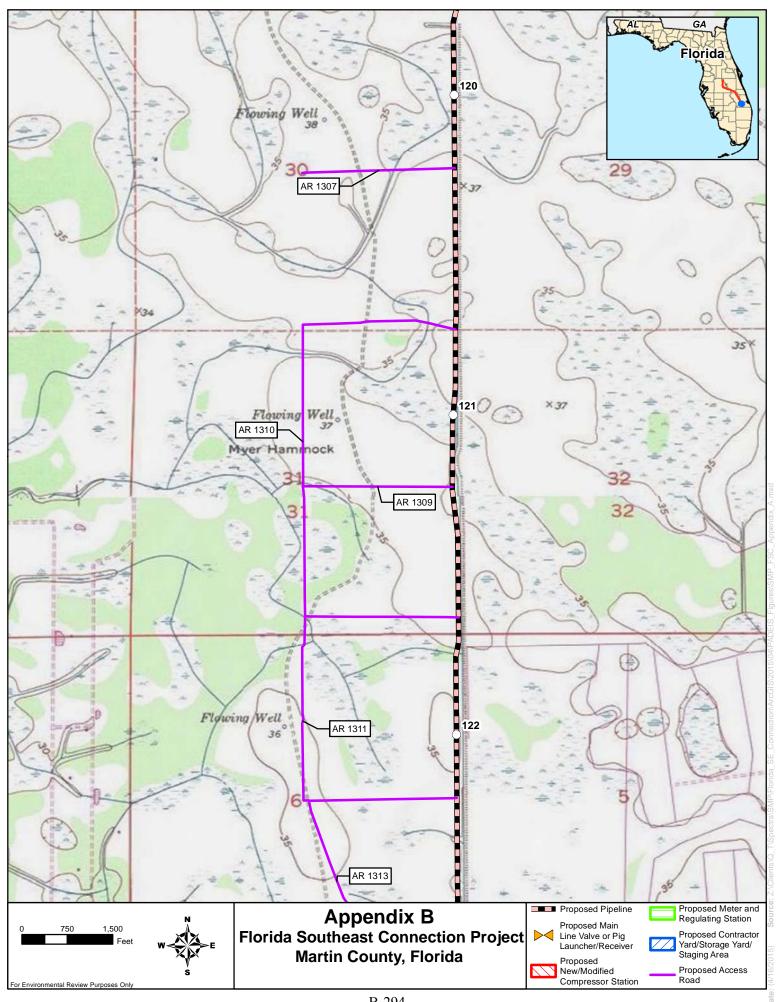

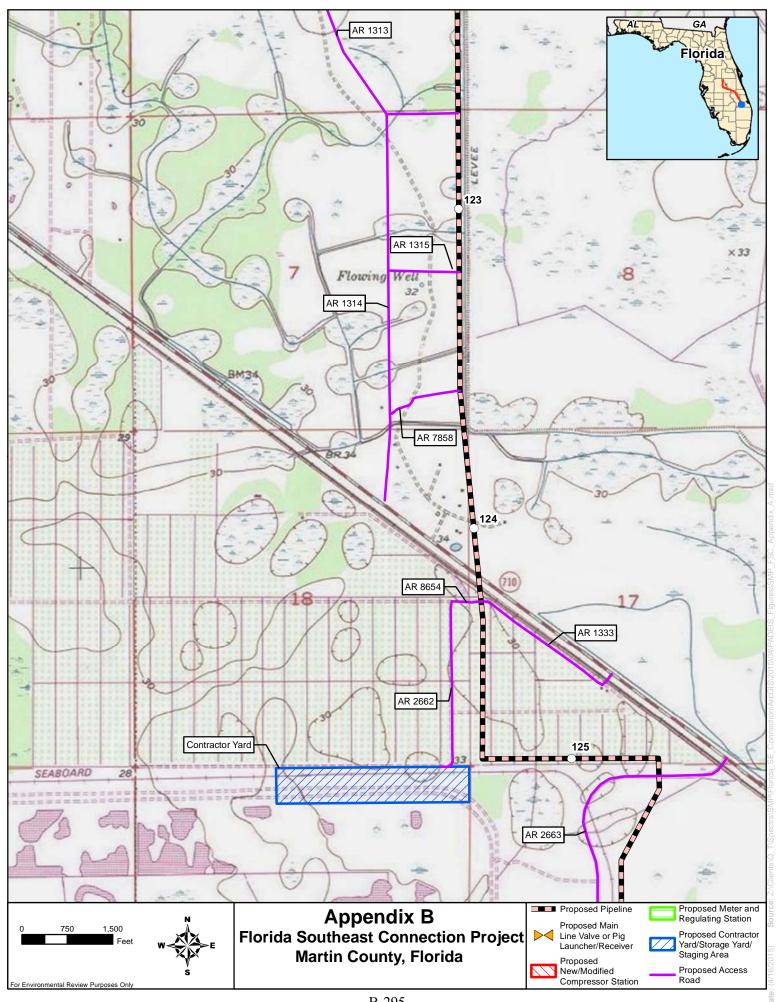


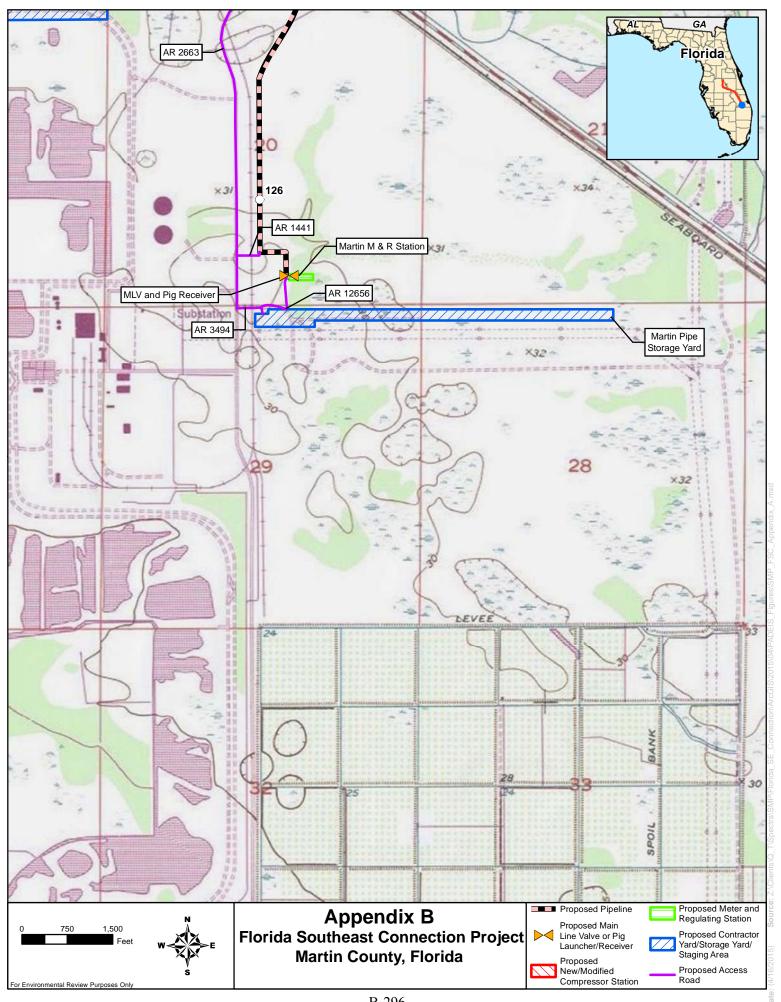


APPENDIX C

TYPICAL RIGHT-OF-WAY CONSTRUCTION DRAWINGS



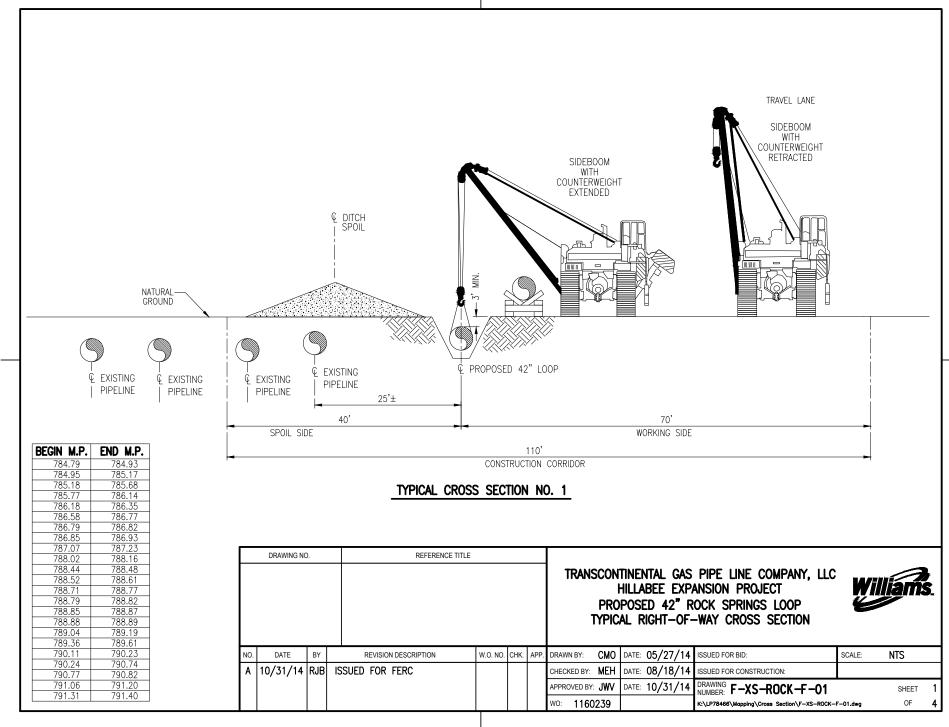


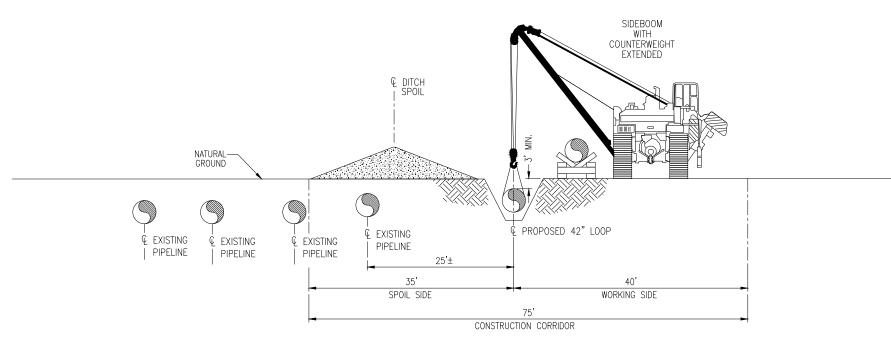

BEGIN M.P.	END M.P.
784.93	784.95
785.17	785.18
785.68	785.77
786.14	786.18
786.77	786.79
786.82	786.85
786.93	787.07
788.16	788.44
788.48	788.49
788.61	788.71
788.77	788.79
788.83	788.85
788.87	788.88
788.89	789.04
789.31	789.36
789.61	790.11
790.74	790.77
791.20	791.31

TYPICAL CROSS SECTION NO. 2

	NO. DATE BY REVISION DESCRIPTION A 10/31/14 RJB ISSUED FOR FERC				E			PRO	HILLABEE EXP POSED 42" R	PIPE LINE COMPANY, LLC ANSION PROJECT OCK SPRINGS LOOP -WAY CROSS SECTION	Wi	lliam	3 S.
	NO.	DATE	BY	REVISION DESCRIPTION	W.O. NO.	CHK.	APP.	DRAWN BY: CMO	DATE: 05/27/14	ISSUED FOR BID:	SCALE:	NTS	
Γ	Α	10/31/14	RJB	ISSUED FOR FERC				CHECKED BY: MEH	DATE: 08/18/14	ISSUED FOR CONSTRUCTION:			
								APPROVED BY: JWV	DATE: 10/31/14	DRAWING F-XS-ROCK-F-02		SHEET	2
								wo: 1160239		K:\LP78466\Mapping\Cross Section\F-XS-ROCK-	F-02.dwg	OF	4

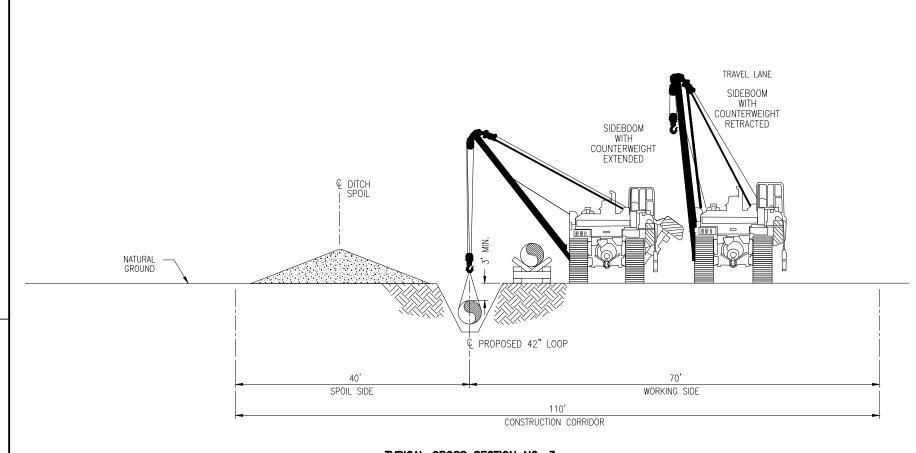

TYPICAL CROSS SECTION NO. 3

BEGIN M.P.	END M.P.
786.35	786.42
786.49	786.50
786.54	786.58
787.23	787.24
787.26	787.40
787.44	787.65
787.66	787.74
787.78	787.83
787.84	787.93
787.95	787.99
788.01	788.02
789.19	789.20
789.21	789.28
790.82	790.94

DRAWING NO.	REFERENCE TITLE	
		TRANSCONTINENTAL GAS PIPE LINE COMPANY, LLC HILLABEE EXPANSION PROJECT PROPOSED 42" ROCK SPRINGS LOOP TYPICAL RIGHT-OF-WAY CROSS SECTION


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OF

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I	NO.	DATE	BY	REVISION DESCRIPTION	W.O. NO.	CHK.	APP.	DRAWN BY:	СМО	DATE: 05/27/14	ISSUED FOR BID:	SCALE:	NTS	
ſ	Α	10/31/14	RJB	ISSUED FOR FERC				CHECKED BY:	MEH	DATE: 08/18/14	ISSUED FOR CONSTRUCTION:			
ı								APPROVED BY:	JWV	DATE: 10/31/14	DRAWING F-XS-ROCK-F-03		SHEET	3


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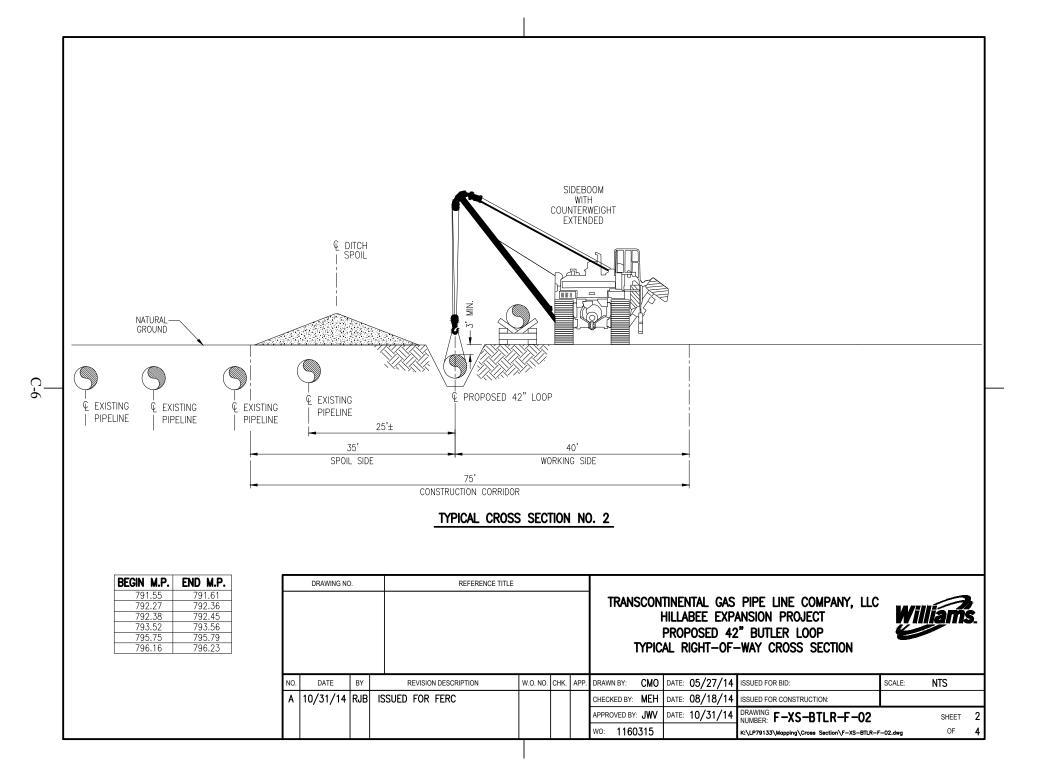



TYPICAL CROSS SECTION NO. 4

BEGIN M.P.	END M.P.
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786.50	786.54
787.24	787.26
787.40	787.44
787.65	787.66
787.74	787.78
787.93	787.95
787.99	788.01
789.20	789.21
790.94	791.06

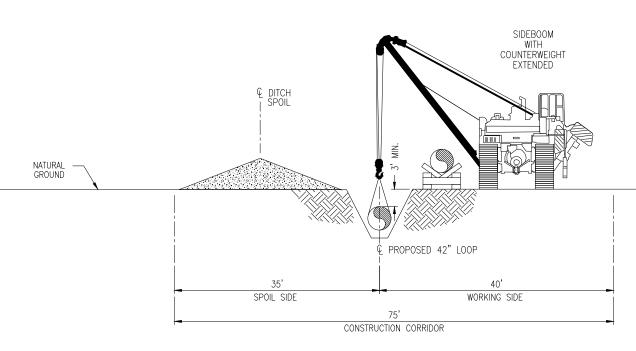
DRAWING NO. REFERENCE TITLE NO. DATE BY REVISION DESCRIPTION A 10/31/14 RJB ISSUED FOR FERC							PRO	HILLABEE EXP. POSED 42" R	PIPE LINE COMPANY, LLC ANSION PROJECT OCK SPRINGS LOOP -WAY CROSS SECTION	Wil E	liam:	5.
NO.	DATE	BY	REVISION DESCRIPTION	W.O. NO.	CHK.	APP.	DRAWN BY: CMO	DATE: 05/27/14	ISSUED FOR BID:	SCALE:	NTS	
Α	10/31/14	RJB	ISSUED FOR FERC				CHECKED BY: MEH	DATE: 08/18/14	ISSUED FOR CONSTRUCTION:			
							APPROVED BY: JWV	DATE: 10/31/14	DRAWING F-XS-ROCK-F-04		SHEET	4
							wo: 1160239		K:\LP78466\Mapping\Cross Section\F-XS-ROCK-	F-04.dwg	OF	4



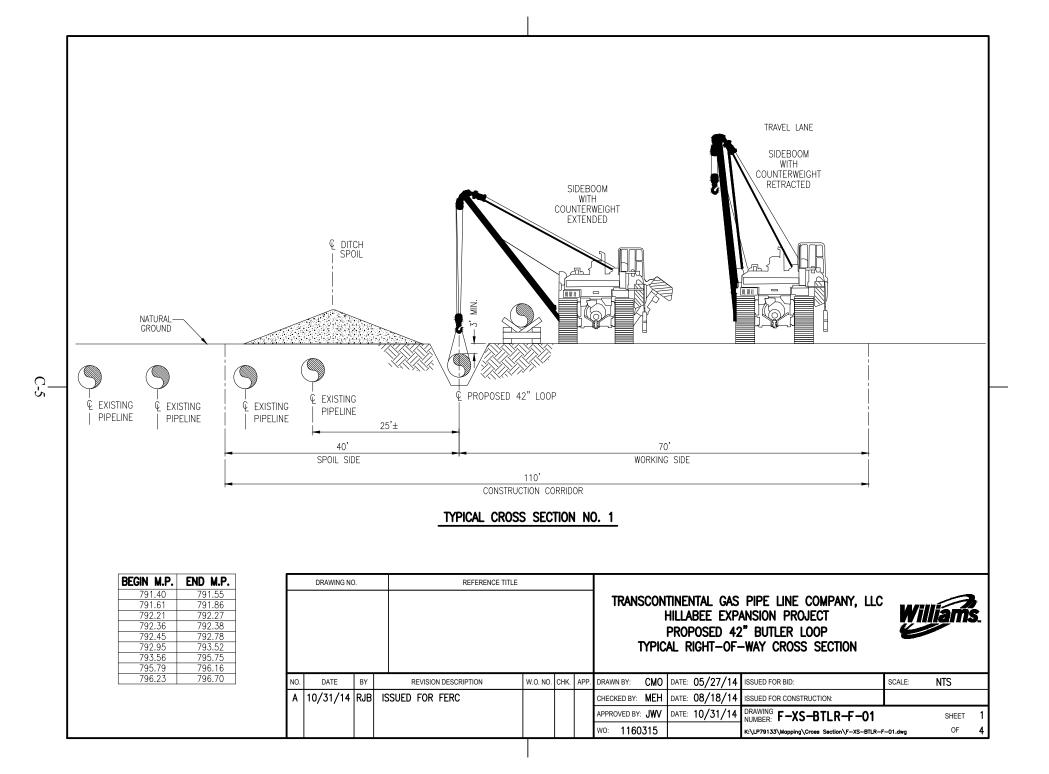

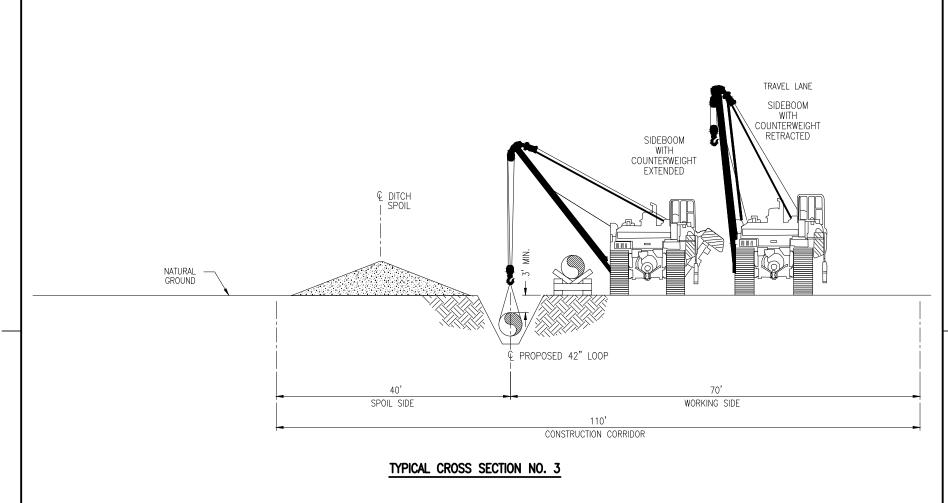

792.04 792.78	END M.P. 792.18 792.93		DRAWING NO).	REFERENCE TITLE				!	HILLABEE EXP PROPOSED 42	PIPE LINE COMPANY, LLC ANSION PROJECT 2" BUTLER LOOP -WAY CROSS SECTION	Wil	liam:) S.
		NO.	DATE	BY	REVISION DESCRIPTION	W.O. NO.	CHK.	APP.	DRAWN BY: CMO	DATE: 05/27/14	ISSUED FOR BID:	SCALE:	NTS	
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REFERENCE TITLE

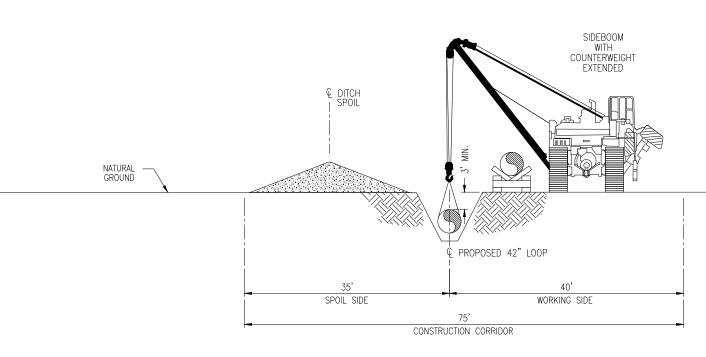BEGIN M.P.	END M.P.
791.94	791.99
792.01	792.04
792.18	792.21
792.93	792.95

DRAWING NO.

	TRANSCONTINENTAL GAS PIPE LINE COMPANY, LLC HILLABEE EXPANSION PROJECT
	PROPOSED 42" BUTLER LOOP
	TYPICAL RIGHT-OF-WAY CROSS SECTION

Williams.

L	NO.	DATE	BY	REVISION DESCRIPTION	W.O. NO.	CHK.	APP.	DRAWN BY: CMO	DATE	: 05/27/14	ISSUED FOR BID:	SCALE:	NTS	
	Α	10/31/14	RJB	ISSUED FOR FERC				CHECKED BY: MEH	DATE	: 08/18/14	ISSUED FOR CONSTRUCTION:			
1								APPROVED BY: JWV	DATE	10/31/14	DRAWING F-XS-BTLR-F-04		SHEET	4
١								wo: 1160315			K:\LP79133\Mapping\Cross Section\F-XS-BTLR-F	-04.dwg	OF	4

BY

DATE A 10/31/14 RJB REVISION DESCRIPTION

ISSUED FOR FERC

W.O. NO. CHK.

DRAWN BY:

CHECKED BY: MEH

APPROVED BY: JWV

wo: 1156827

CMO DATE: 05/27/14

DATE: 08/18/14

DATE: 10/31/14

ISSUED FOR BID:

ISSUED FOR CONSTRUCTION:

DRAWING F-XS-BILL-E-01


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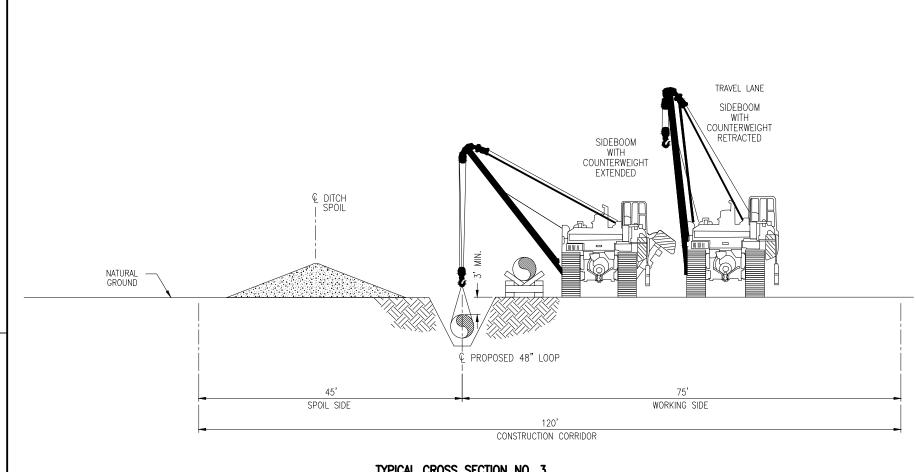
SCALE:

NTS


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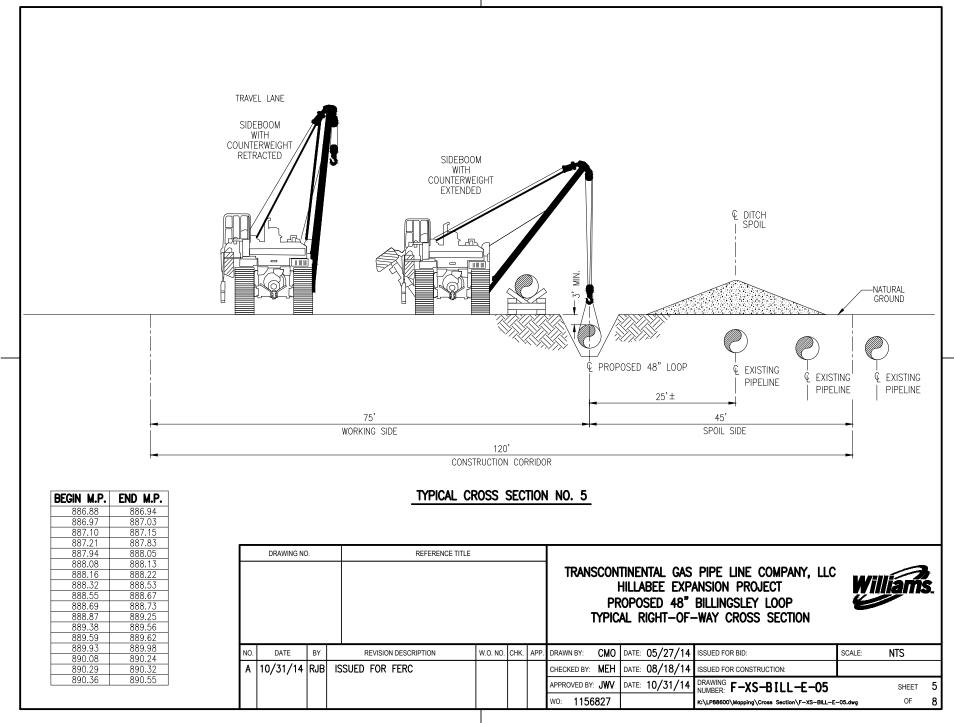
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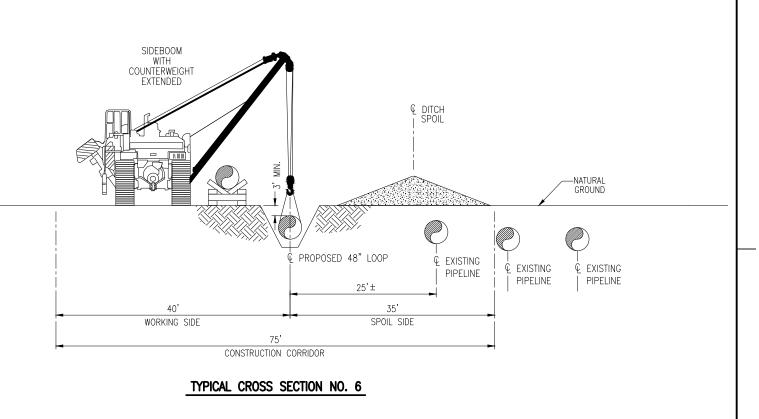




886.17 886.53	END M.P. 886.24 886.74		DRAWING N	0.	REFERENCE TITLE				PF	HILLABEE EXP. ROPOSED 48"	PIPE LINE COMPANY, LLC ANSION PROJECT BILLINGSLEY LOOP -WAY CROSS SECTION	W	lliam) S .
		N	D. DATE	BY	REVISION DESCRIPTION	W.O. NO.	CHK.	APP.	DRAWN BY: CMO	DATE: 05/27/14	ISSUED FOR BID:	SCALE:	NTS	
		7	10/31/14	RJB	ISSUED FOR FERC						ISSUED FOR CONSTRUCTION:			
									APPROVED BY: JWV		DRAWING F-XS-BILL-E-03		SHEET	
								l	wo: 1156827		K:\LP88600\Mapping\Cross Section\F-XS-BILL-E	-03.dwg	OF	8

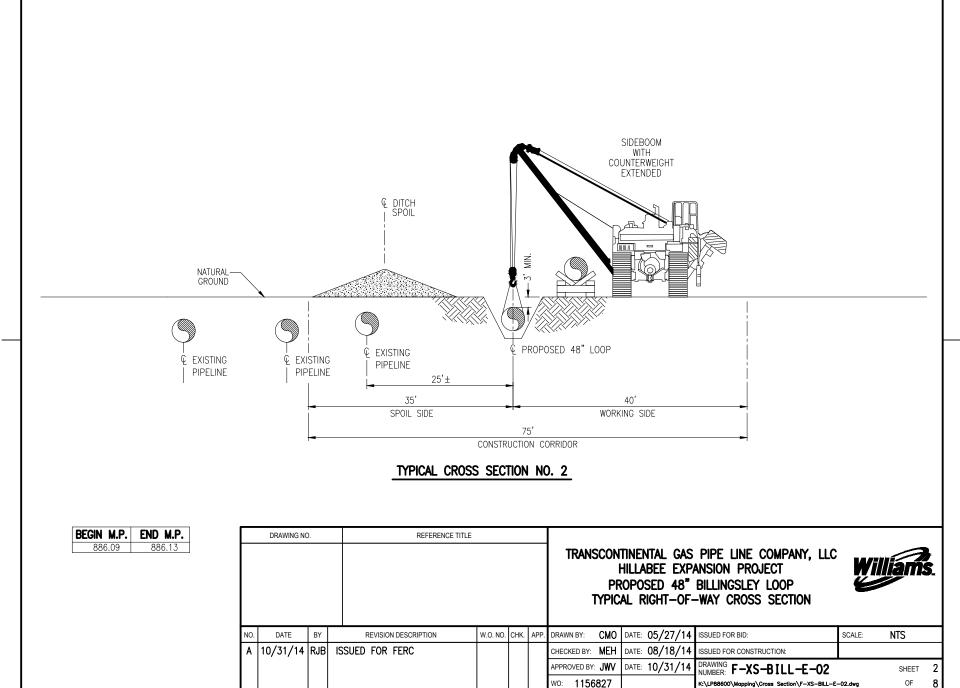



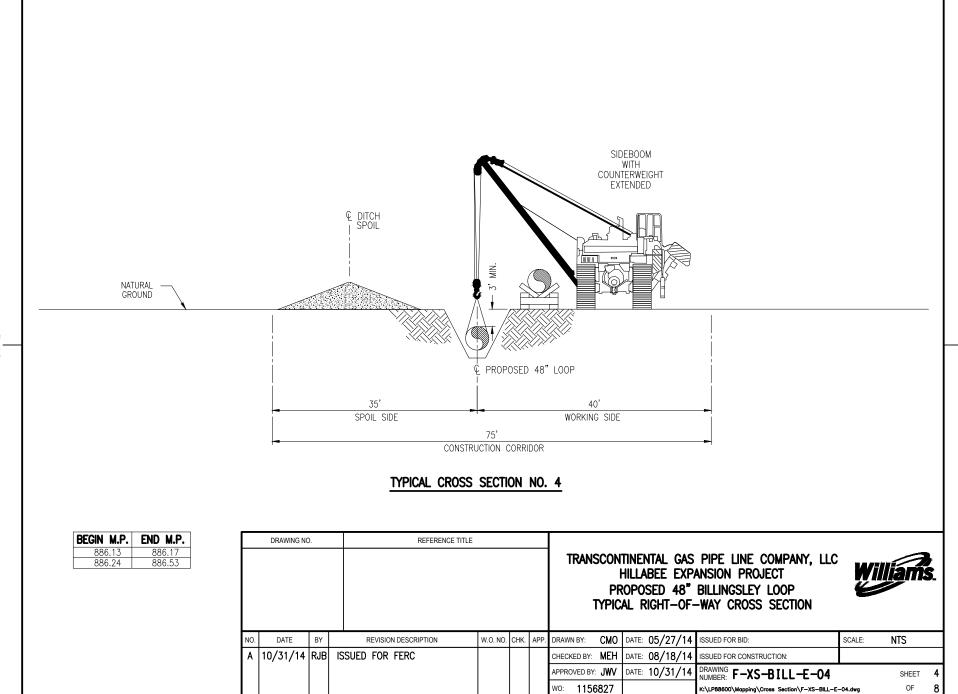

886.79	886.84
886.86	886.88
886.94	886.97
887.19	887.21
887.86	887.92
888.05	888.08
888.13	888.16
888.22	888.24
888.53	888.55
888.67	888.69
888.73	888.75
889.29	889.34
889.56	889.59
889.62	889.74
889.87	889.93
889.98	890.08
890.24	890.26


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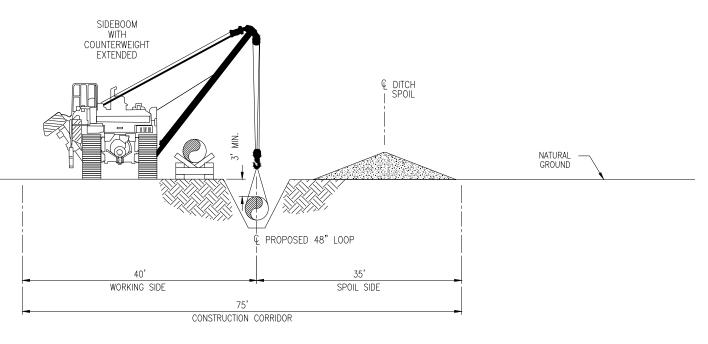
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REFERENCE TITLE TRANSCONTINENTAL GAS PIPE LINE COMPANY, LLC

21.0	1,500	
PROPOSED 48" BILLINGSLEY LOOP TYPICAL RIGHT-OF-WAY CROSS SECTION		
HILLABEE EXPANSION PROJECT	WIIIIAMS.	

NO.	DATE	BY	REVISION DESCRIPTION	W.O. NO.	CHK.	APP.	DRAWN BY: CMO	DATE: 05/2//14	ISSUED FOR BID:	SCALE:	NIS	
Α	10/31/14	RJB	ISSUED FOR FERC				CHECKED BY: MEH	DATE: 08/18/14	ISSUED FOR CONSTRUCTION:			
							APPROVED BY: JWV	DATE: 10/31/14	DRAWING F-XS-BILL-E-06		SHEET	6
							wo: 1156827		K:\LP88600\Mapping\Cross Section\F-XS-BILL-E	-06.dwg	OF	8



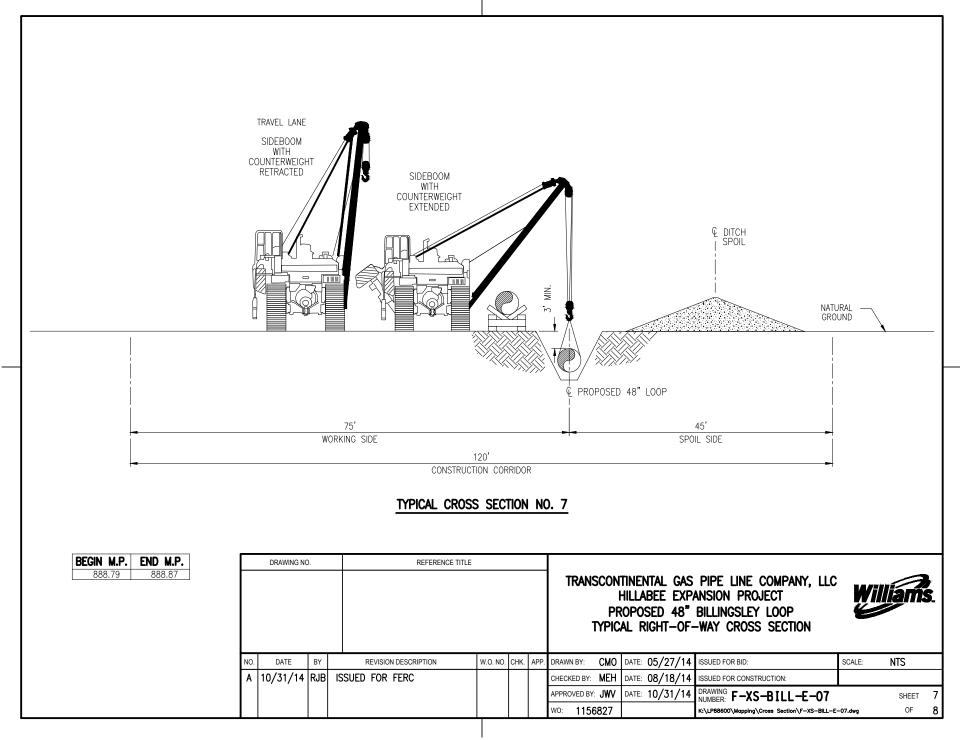

REFERENCE TITLE

888.77	888.79				Г
889.74	889.87				
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DRAWING NO.

BEGIN M.P. END M.P.


TRANSCONTINENTAL GAS PIPE LINE COMPANY, LLC HILLABEE EXPANSION PROJECT PROPOSED 48" BILLINGSLEY LOOP TYPICAL RIGHT-OF-WAY CROSS SECTION

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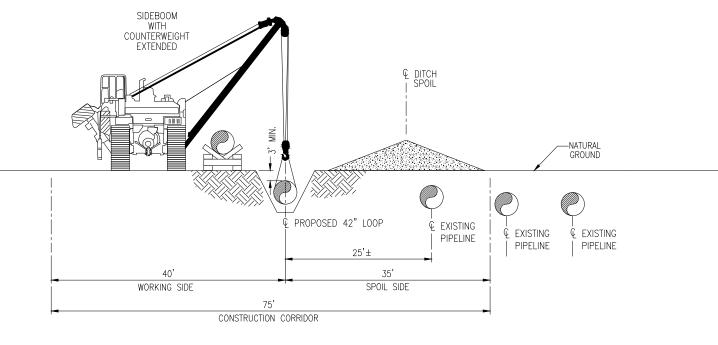
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							APPROVED BY:	JWV	DATE: 10/31/14	DRAWING F-YS-RILL-F-08		SHEET	8

wo: 1156827




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892.35	892.66
893.30	893.38
893.41	893.51
893.55	893.69
893.73	894.26
894.28	894.66
894.68	895.09
895.12	895.16
895.21	895.37
895.42	897.58
897.60	897.76
897.87	898.15

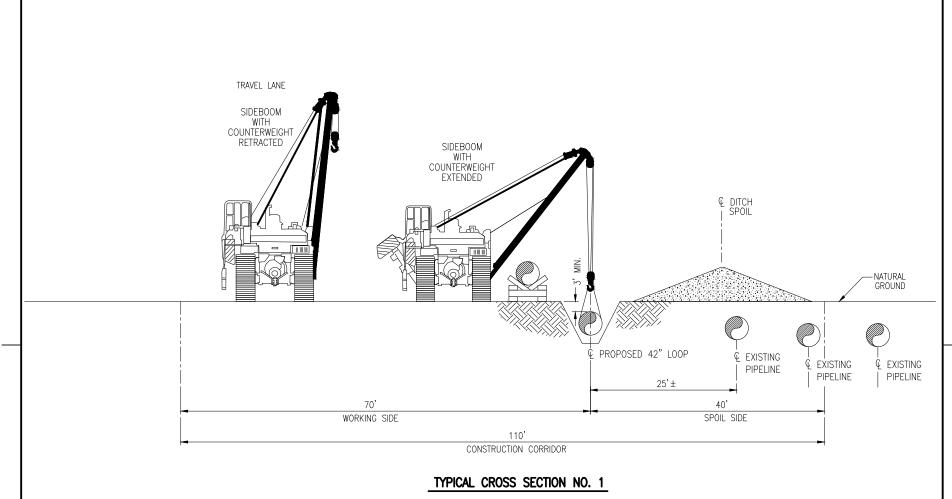
	DRAWING NO).	REFERENCE TITLE				l F	HILLABEE EXPA PROPOSED 42	PIPE LINE COMPANY, LLC ANSION PROJECT " AUTAUGA LOOP -WAY CROSS SECTION	Wil	lliam s	5.
NC	DATE	BY	REVISION DESCRIPTION	W.O. NO.	CHK.	APP.	DRAWN BY: CMO	DATE: 05/28/14	ISSUED FOR BID:	SCALE:	NTS	
Α	10/31/14	RJB	ISSUED FOR FERC				CHECKED BY: MEH	DATE: 08/18/14	ISSUED FOR CONSTRUCTION:			
							APPROVED BY: JWV	DATE: 10/31/14	DRAWING F-XS-AUTG-F-01		SHEET	1
							wo: 1160321		K:\LP89069\Mapping\Cross Section\F-XS-AUTG-	F-01.dwg	OF	4



BEGIN M.P.	END M.P.			
892.66	892.97			
893.08	893.30			
893.38	893.41			
893.51	893.55			
893.69	893.73			
894.26	894.28			
894.66	894.68			
895.09	895.12			
895.16	895.21			
895.37	895.42			
897.58	897.60			
897.79	897.82			


	DRAWING NO	D	REFERENCE TITL	.E				HI Pf	ILLABEE EXP ROPOSED 42	PIPE LINE COMPANY, LLC ANSION PROJECT " AUTAUGA LOOP -WAY CROSS SECTION	Wil	llam:	3 S.
NO.	DATE	BY	REVISION DESCRIPTION	W.O. NO.	CHK.	APP.	DRAWN BY: CN	MO [DATE: 05/28/14	ISSUED FOR BID:	SCALE:	NTS	
	10/31/14	RJB	ISSUED FOR FERC				CHECKED BY: ME	EH [DATE: 08/18/14	ISSUED FOR CONSTRUCTION:			
Α	10/31/14				1								
A	10/31/14						APPROVED BY: JW	W	DATE: 10/31/14	DRAWING F-XS-AUTG-F-02		SHEET	2

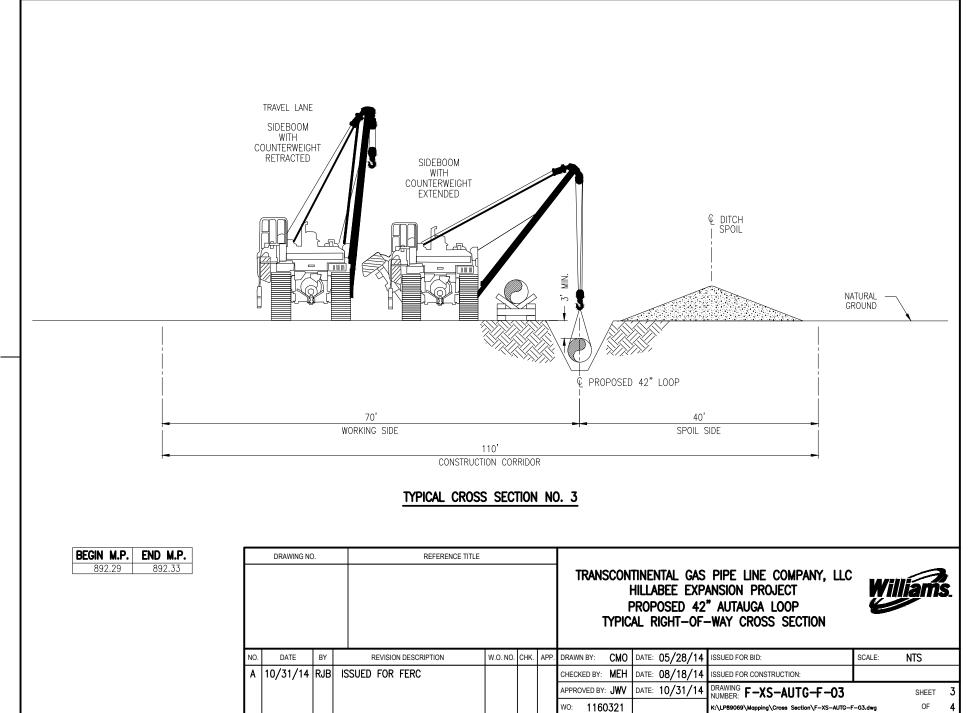

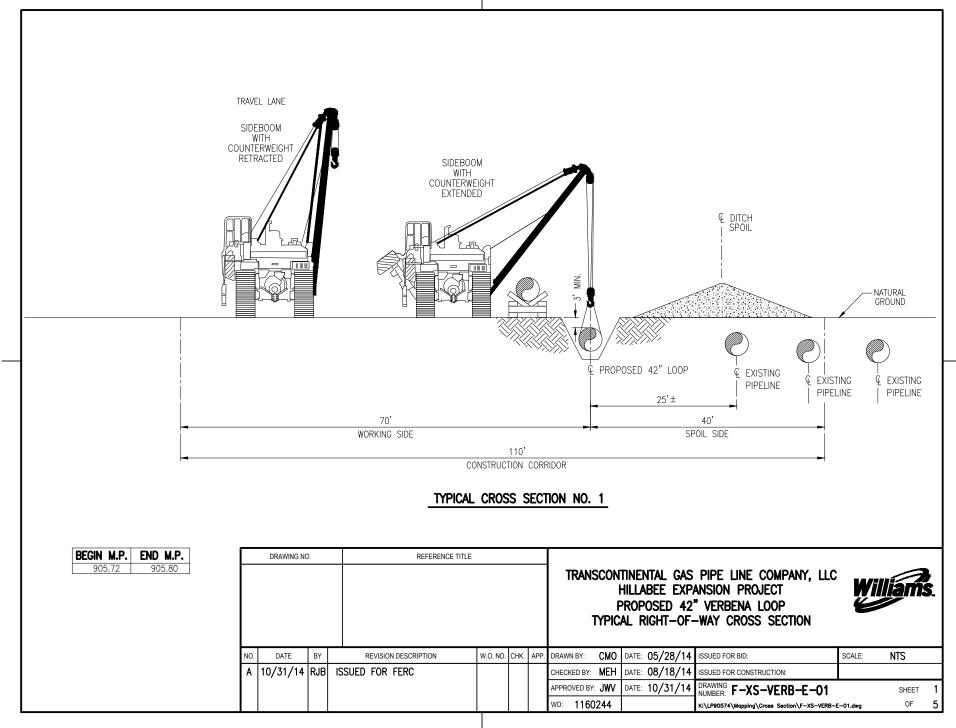


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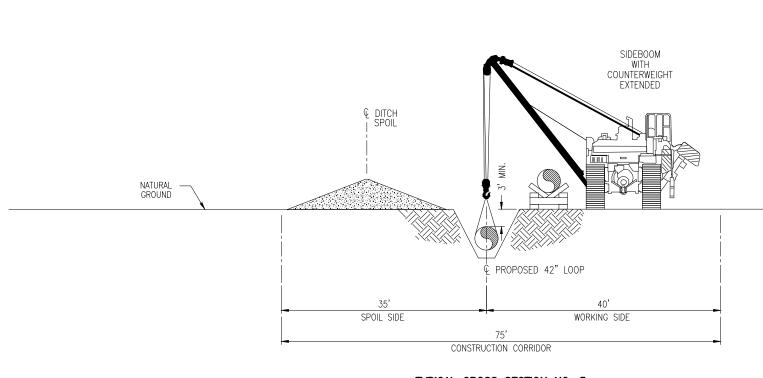


BEGIN M.P.	END M.P.
905.94	905.99
906.58	906.61
908.22	908.23
908.53	908.56
909.36	909.39

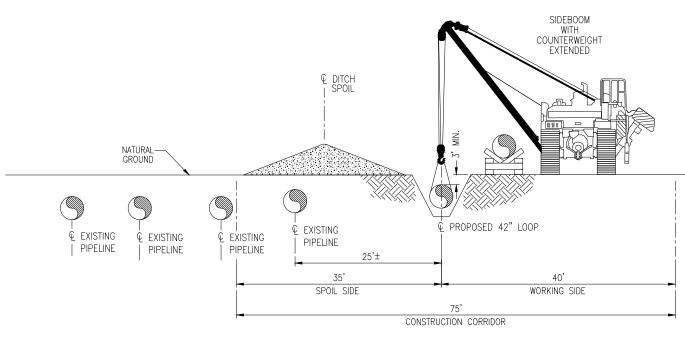	DRAWING NO).	REFERENCE TITLE				ļ .	HILLABEE EXPA PROPOSED 42	PIPE LINE COMPANY, LLC ANSION PROJECT "VERBENA LOOP -WAY CROSS SECTION	Wi	lliam	S .
NO.	DATE	BY	REVISION DESCRIPTION	W.O. NO.	CHK.	APP.	DRAWN BY: CMO	DATE: 05/28/14	ISSUED FOR BID:	SCALE:	NTS	
Α	10/31/14	RJB	ISSUED FOR FERC				CHECKED BY: MEH	DATE: 08/18/14	ISSUED FOR CONSTRUCTION:			
							APPROVED BY: JWV	DATE: 10/31/14	DRAWING F-XS-VERB-E-03		SHEET	3
							wo: 1160244		K:\LP90574\Mapping\Cross Section\F-XS-VERB-I	E-03.dwg	OF	5



BEGIN M.P. 906.71 906.87 907.17	906.85 907.15 907.26		DRAWING NO	D.	REFERENCE TITLE					HILLABEE EXP PROPOSED 42	PIPE LINE COMPANY, LLC ANSION PROJECT "VERBENA LOOP -WAY CROSS SECTION	Wi	lliaris.
		NO.	DATE	BY	REVISION DESCRIPTION	W.O. NO.	CHK.	APP.	DRAWN BY: CMC	DATE: 05/28/14	ISSUED FOR BID:	SCALE:	NTS
		Α	10/31/14	RJB	ISSUED FOR FERC						ISSUED FOR CONSTRUCTION:		
									APPROVED BY: JW	DATE: 10/31/14	DRAWING F-XS-VERB-E-04		SHEET 4

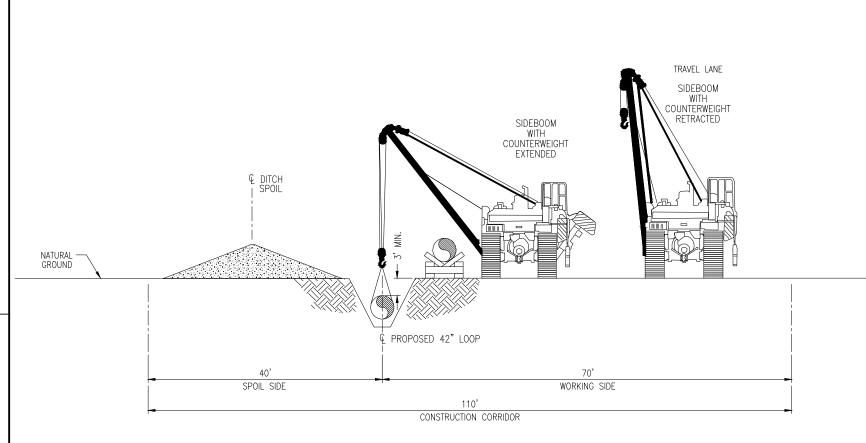



END M.P.
906.87
907.17

DRAWING NO.	REFERENCE TITLE	
		TRANSCONTINENTAL GAS PIPE LINE COMPANY, LLC HILLABEE EXPANSION PROJECT PROPOSED 42" VERBENA LOOP TYPICAL RIGHT-OF-WAY CROSS SECTION

Williams.


	NO.	DATE	BY	REVISION DESCRIPTION	W.O. NO.	CHK.	APP.	DRAWN BY: CMO	DATE: 05/28/14	ISSUED FOR BID:	SCALE:	NTS	
Г	Α	10/31/14	RJB	ISSUED FOR FERC				CHECKED BY: MEH	DATE: 08/18/14	ISSUED FOR CONSTRUCTION:			
ı								APPROVED BY: JWV	DATE: 10/31/14	DRAWING F-XS-VERB-E-05		SHEET	5
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BEGIN M.P.	END M.P.
911.80	911.84
912.06	912.09
912.31	912.33
913.70	913.73
913.77	913.79
914.74	914.77
915.12	915.17
915.89	915.91
916.21	916.23

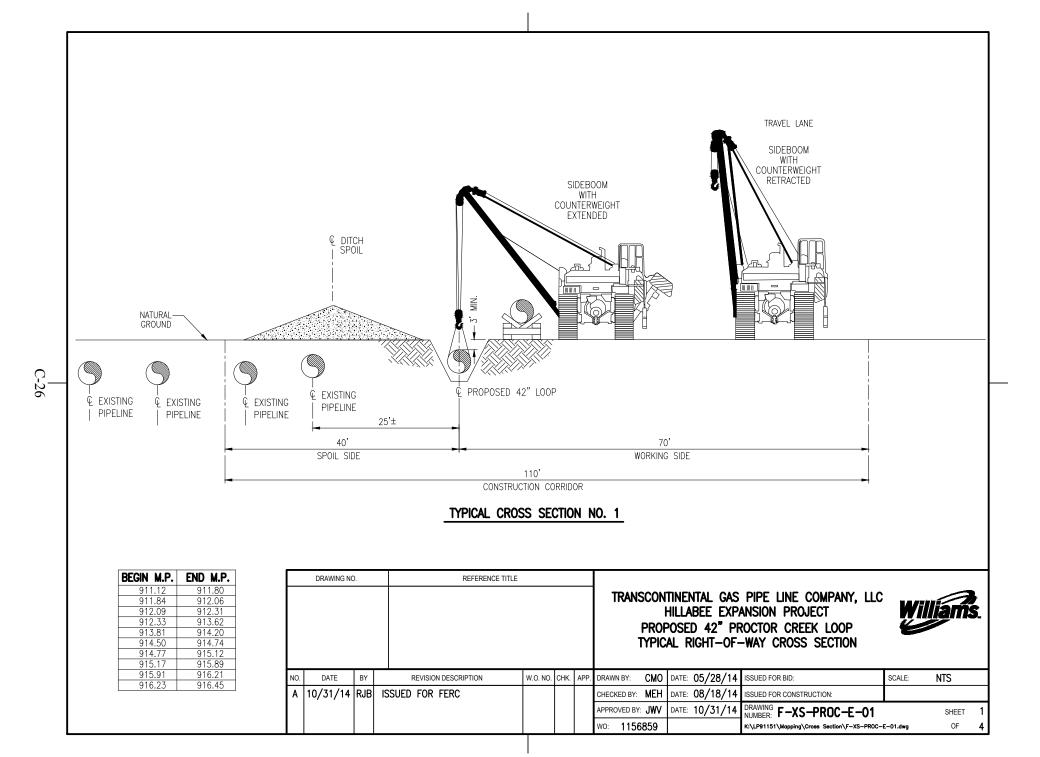	DRAWING NO).	REFERENCE TITLE				PROF	HILLABEE EXPA POSED 42" PF	PIPE LINE COMPANY, LLC ANSION PROJECT ROCTOR CREEK LOOP -WAY CROSS SECTION	Wil	liams	S .
NO.	DATE	BY	REVISION DESCRIPTION	W.O. NO.	CHK.	APP.	DRAWN BY: CMO	DATE: 05/28/14	ISSUED FOR BID:	SCALE:	NTS	\Box
Α	10/31/14	RJB	ISSUED FOR FERC				CHECKED BY: MEH	DATE: 08/18/14	ISSUED FOR CONSTRUCTION:			
							APPROVED BY: JWV	DATE: 10/31/14	DRAWING NUMBER: F-XS-PROC-E-02		SHEET	2
							wo: 1156859		K:\LP91151\Mapping\Cross Section\F-XS-PROC-	E-02.dwg	OF	4

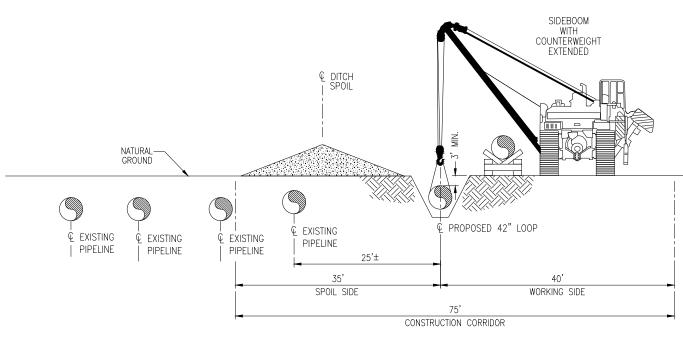


APPROVED BY: JWV


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SHEET

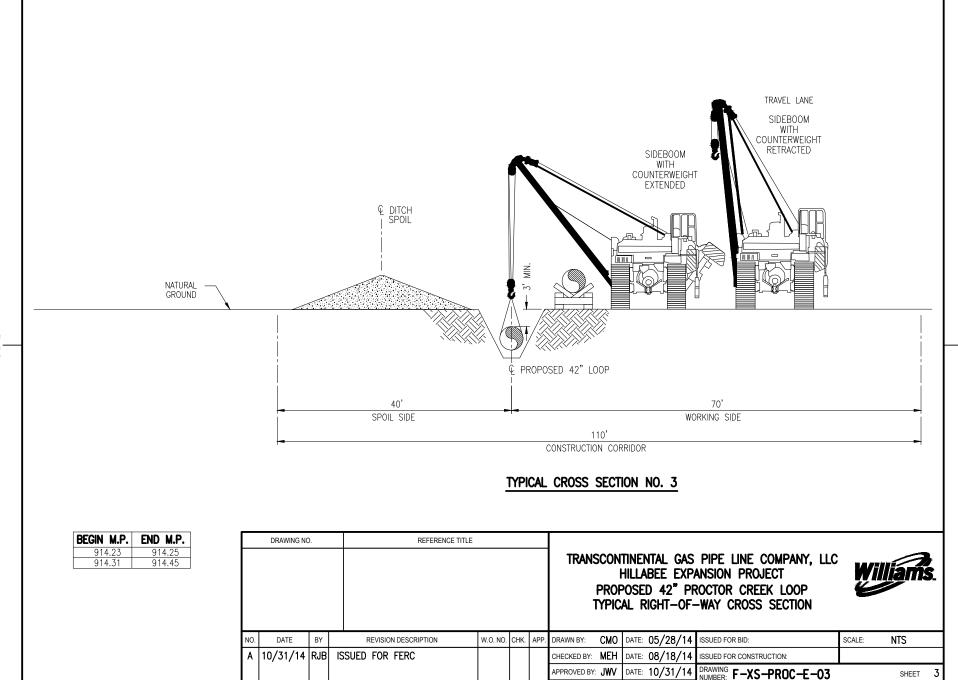
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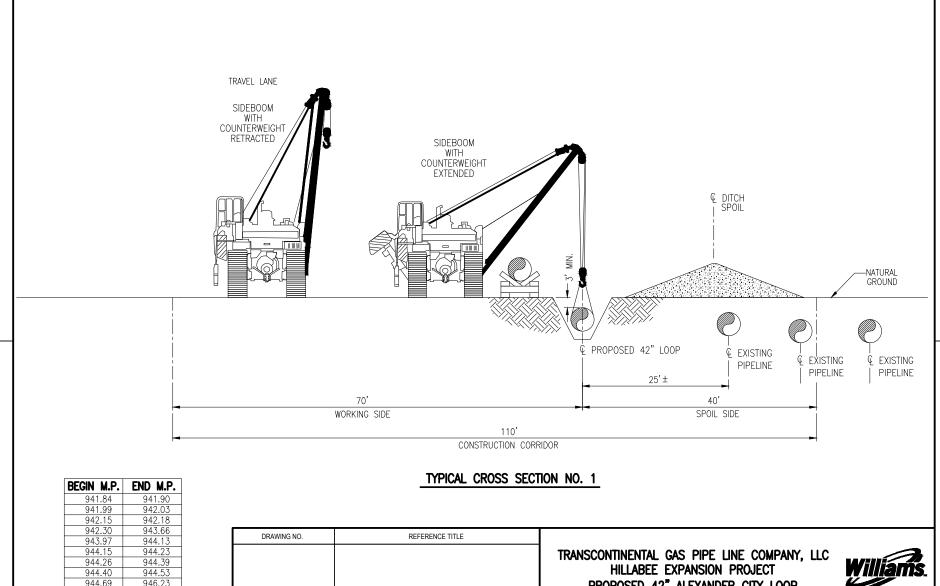


924.27 925.09 925.92 926.08	925.08 925.91 926.06 926.85	925.08 925.91 926.06 926.85				REFERENCE TITLE					HILLABEE EXP PROPOSED 4:	PIPE LINE COMPANY, LLC ANSION PROJECT 2" HISSOP LOOP -WAY CROSS SECTION	W	illiams.
			NO.	DATE	BY	REVISION DESCRIPTION	W.O. NO.	CHK.	APP.	DRAWN BY: CMC	DATE: 05/28/14	ISSUED FOR BID:	SCALE:	NTS
			Α	10/31/14	RJB	ISSUED FOR FERC				CHECKED BY: MEH	DATE: 08/18/14	ISSUED FOR CONSTRUCTION:		
										APPROVED BY: JWV	DATE: 10/31/14	DRAWING F-XS-HISS-E-01		SHEET 1

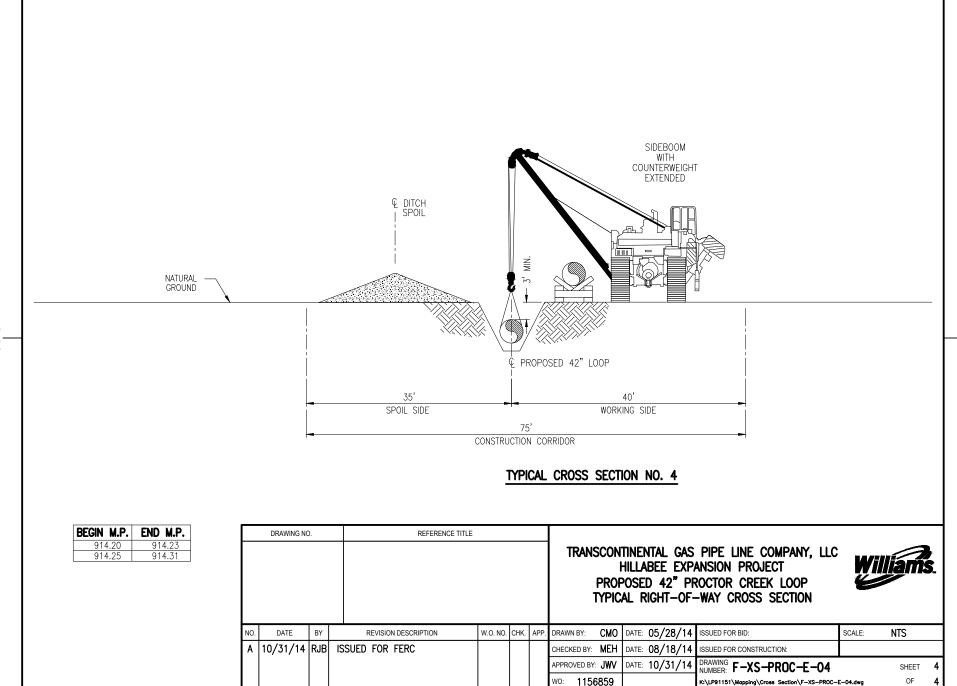

BEGIN M.P.	END M.P.
925.08	925.09
925.91	925.92
926.06	926.08
926.06	926.08

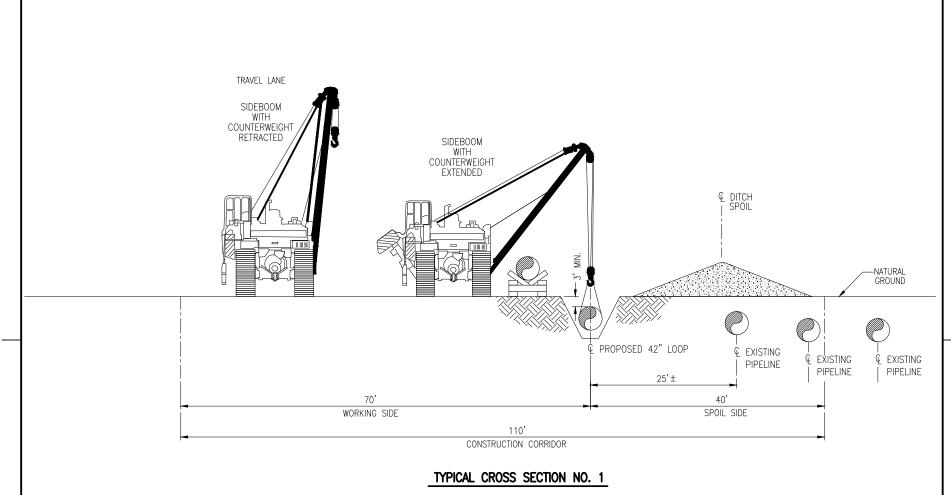	DRAWING NO		REFERENCE TITLE				1	HILLABEE EXPA PROPOSED 42	PIPE LINE COMPANY, LLC ANSION PROJECT 2" HISSOP LOOP -WAY CROSS SECTION	Wil	liam :	5 .
NO.	DATE	BY	REVISION DESCRIPTION	W.O. NO.	CHK.	APP.	DRAWN BY: CMO	DATE: 05/28/14	ISSUED FOR BID:	SCALE:	NTS	
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944.39
944.53
946.23
946.93
947.30
947.44
948.38
948.98
949.37

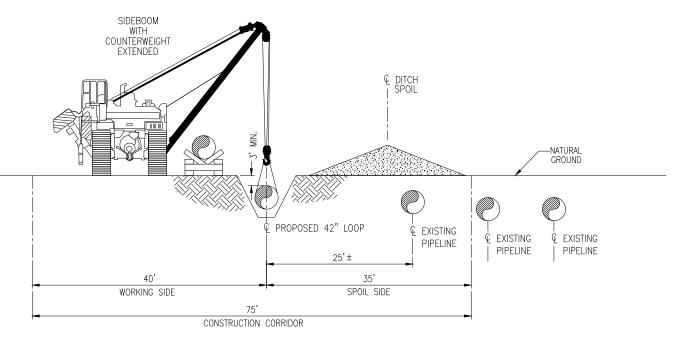PROPOSED 42" ALEXANDER CITY LOOP TYPICAL RIGHT-OF-WAY CROSS SECTION


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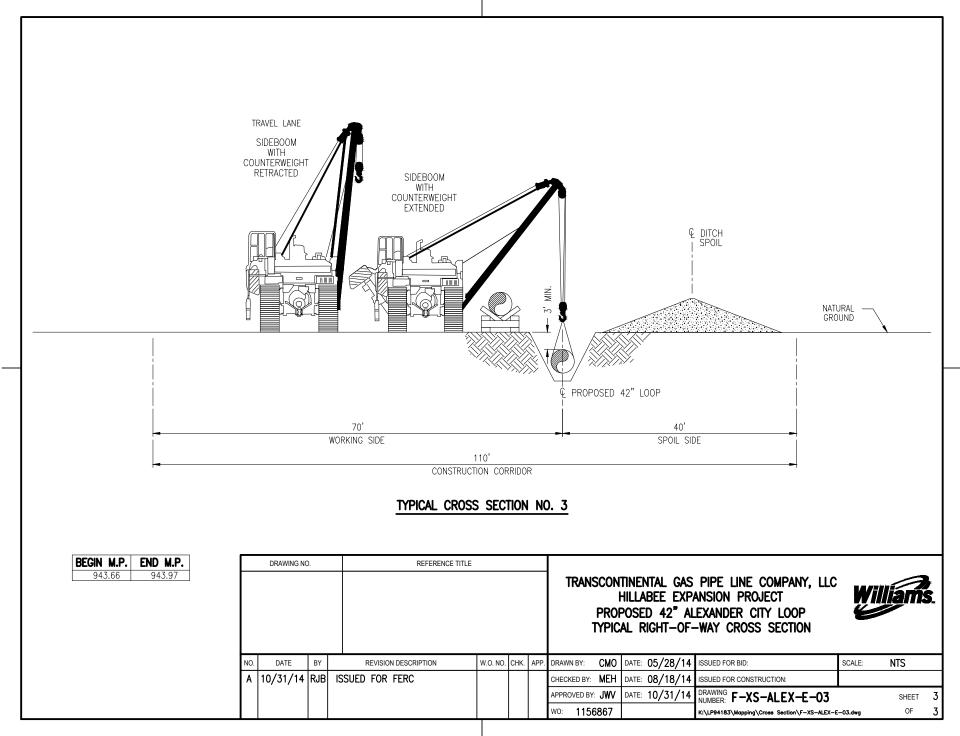
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ſ	Α	10/31/14	RJB	ISSUED FOR FERC				CHECKED BY: MEH	D.A	ATE: 08/18/14	ISSUED FOR CONSTRUCTION:			
ı								APPROVED BY: JW	DA	ATE: 10/31/14	DRAWING F-XS-ALEX-E-01		SHEET	1

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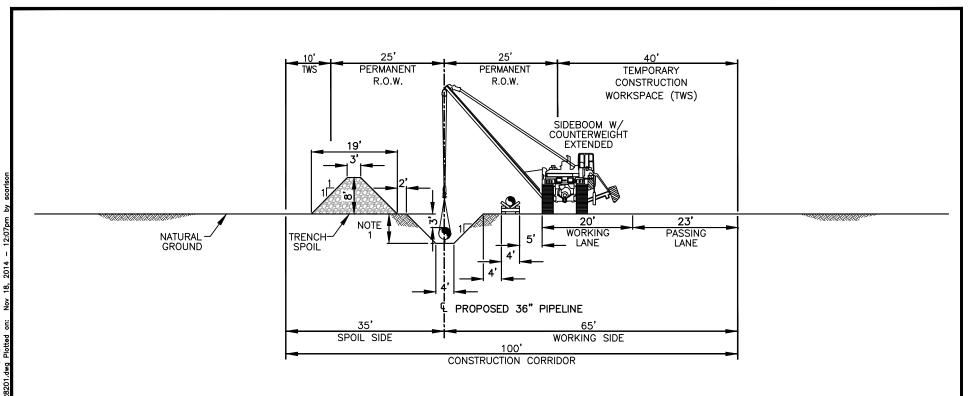


END M.P.
942.05
942.30
944.15
944.26
944.40
944.68
946.26
946.95
947.33
947.46
948.40
949.01

	DRAWING NO	D.	REFERENCE TIT	LE			PRO	HILLABEE EXP. POSED 42" AI	PIPE LINE COMPANY, LLC ANSION PROJECT LEXANDER CITY LOOP -WAY CROSS SECTION	Wil	liam:) S .
NC	. DATE	BY	REVISION DESCRIPTION	W.O. NO.	CHK.	APP.	DRAWN BY: CMO	DATE: 05/28/14	ISSUED FOR BID:	SCALE:	NTS	
Α	10/31/14	RJB	ISSUED FOR FERC				CHECKED BY: MEH	DATE: 08/18/14	ISSUED FOR CONSTRUCTION:			
							APPROVED BY: JWV	DATE: 10/31/14	DRAWING F-XS-ALEX-E-02		SHEET	2
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TYPICAL CONSTRUCTION CORRIDOR

N.T.S.

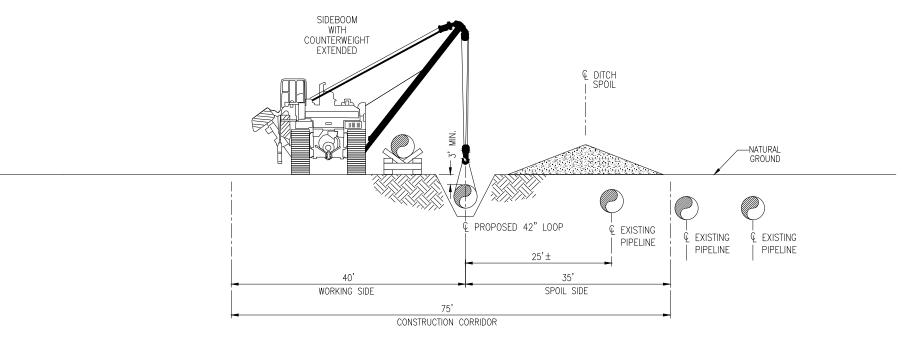NOTES:

- 1. MINIMUM TRENCH DEPTH WILL BE 6'-6".
- 2. THIS CONSTRUCTION METHOD APPLIES TO LOCATIONS WHERE THE APPLICABLE R.O.W. ARRANGEMENT CALLS FOR 25'/25' PERMANENT R.O.W.
- 3. THIS CONSTRUCTION METHOD APPLIES TO FORWARD & REVERSE PIPELINE LAY.

									Sabal Trail
							CHK. JC 5- PROJ. ENGR. PROJ. MGR.	-23-14 -30-14	SABAL TRAIL TRANSMISSION UPLAND CONSTRUCTION WITHOUT TOPSOIL SEGREGATION FIGURE #1
ı	0	ISSUED FOR PERMITTING	NC	11/20/14	JW	JC	CLIENT APP.		DWG. NO. RE
	NO.	REVISION DESCRIPTION	BY	DATE	CHK'D	APP'D	SCALE: AS NOTE		1657-PL-DG-28201 1 OF 1

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NO.

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CLIENT APP.

SCALE: AS NOTED

DWG. NO.

1657-PL-DG-28202

SHT. NO.

1 OF 1

- AND TOPSOIL SEPARATION IS NEEDED.

 4. THIS CONSTRUCTION METHOD APPLIES TO FORWARD & REVERSE PIPELINE LAY.
- 5. FOR ADDITIONAL DETAILS IN REGARDS TO CO-LOCATED UTILITIES REFER TO APPLICABLE R.O.W. ARRANGEMENT.


										_
								Sabal Trail		
						DWN. BY: GIE	4-23-14	SABAL TRAIL TRANSM	SSION	
						CHK. JC	5-28-14	UPLAND CONSTRUC	_	
						PROJ. ENGR.		FULL WIDTH TOPS		
						PROJ. MGR.		SEGREGATION (AL,	GA)	
0	ISSUED FOR PERMITTING	GIE	11/20/2014	JW	JC	CLIENT APP.		FIGURE #3	SHT. NO.	REV.
NO.	REVISION DESCRIPTION	BY	DATE	CHK'D	APP'D	SCALE: AS NOT	ED	1657-PL-DG-28203		0

- AND OTHER AREAS AT THE LANDOWNER'S OR LAND MANAGING AGENCY'S REQUEST.
- 2. MINIMUM TRENCH DEPTH AFTER TOPSOIL IS REMOVED WILL BE 6'-6".
- 3. THIS CONSTRUCTION METHOD APPLIES TO LOCATIONS IN ALABAMA OR GEORGIA WHERE THE APPLICABLE R.O.W. ARRANGEMENT CALLS FOR 35'/15' PERMANENT R.O.W. AND TOPSOIL SEPARATION IS NEEDED.
- 4. THIS CONSTRUCTION METHOD APPLIES TO FORWARD & REVERSE PIPELINE LAY.
- 5. FOR ADDITIONAL DETAILS IN REGARDS TO CO-LOCATED UTILITIES REFER TO APPLICABLE R.O.W. ARRANGEMENT.

									Sabal Trail	
ŀ								4-23-14	SABAL TRAIL TRANSMISSION	
Į							CHK. JC	5-28-14	UPLAND CONSTRUCTION	
							PROJ. ENGR.		FULL WIDTH TOPSOIL	
Ī							PROJ. MGR.		SEGREGATION (AL,GA)	
ı	0	ISSUED FOR PERMITTING	GIE	11/20/14	JW	JC	CLIENT APP.		FIGURE #4	
ŀ	-						SCALE: AC NO			EV.
	NO.	REVISION DESCRIPTION	BY	DATE	CHK'D	APP'D	SCALE: AS NO	TED	1657-PL-DG-28204 1 OF 1 (0

L									Sabal Trail		
ŀ							DWN. BY: NC	4-23-14			
L							CHK. JC	5-28-14	UPLAND CONSTRUCTION		
							PROJ. ENGR.		FULL WIDTH TOPSOIL		
							PROJ. MGR.		SEGREGATION (FL)		
ı	0	ISSUED FOR PERMITTING	NC	11/20/14	JW	JC	CLIENT APP.		FIGURE #5		
ı	NO.	REVISION DESCRIPTION	BY	DATE	CHK'D	APP'D	SCALE: AS NO	DTED	DWG. NO. SHT. NO. REV 1657-PL-DG-28205 1 OF 1 0		


									Sabal Trail		
ŀ							DWN. BY: NC	4-23-14	UPLAND CONSTRUCTION		
ŀ							CHK. JC	5-28-14		_	
							PROJ. ENGR.		FULL WIDTH TOPS	_	
ı							PROJ. MGR.		SEGREGATION (F	L)	
Ī	0	ISSUED FOR PERMITTING	NC	11/20/14	JW	JC	CLIENT APP.		FIGURE #6		
	NO.	REVISION DESCRIPTION	BY	DATE	CHK'D	APP'D	SCALE: AS NO	TED	DWG. NO. 1657-PL-DG-28206	SHT. NO. 1 OF 1	REV.

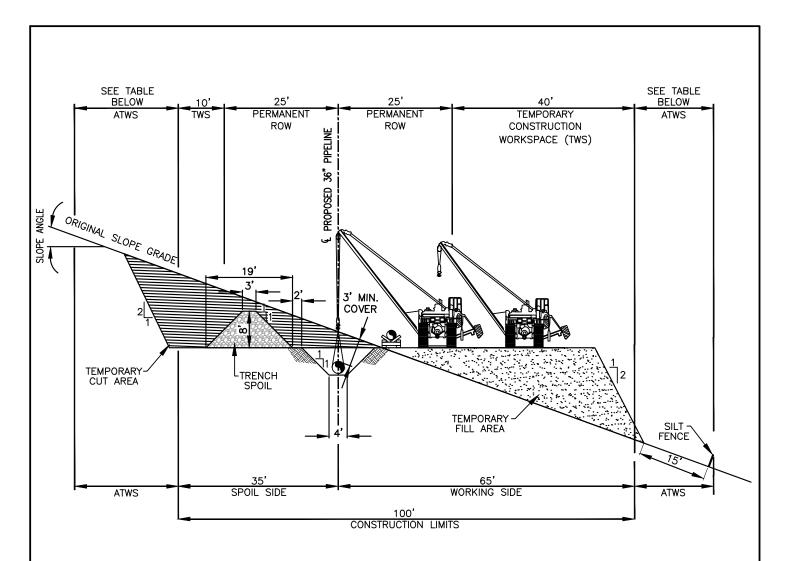

$\underset{\text{N.T.S.}}{\underline{\mathsf{TYPICAL}}} \ \underset{\text{CONSTRUCTION}}{\underline{\mathsf{CORRIDOR}}}$

ADDI	ADDITIONAL TEMPORARY WORKSPACE											
SLOPE ANGLE SPOIL SIDE WORKING SIDE												
0°-10°	0,	15'										
10*-20*	5'	25'										
20°-30°	15'	50'										

								Sabal Trail	
						DWN. BY: GIE	4-23-14		ISSION
						CHK. JC	5-28-14	UPLAND CONSTRUC	TION
						PROJ. ENGR.		TYPICAL SIDE SLC)PE
						PROJ. MGR.		GREENFIELD SECT	ION
0	ISSUED FOR PERMITTING	GIE	11/20/2014	JW	JC	CLIENT APP.		FIGURE #7	
NO.	REVISION DESCRIPTION	BY	DATE	CHK'D	APP'D	SCALE: AS NO	TED	DWG. NO. 1657-PL-DG-28207	SHT. NO. REV. 1 OF 1 0

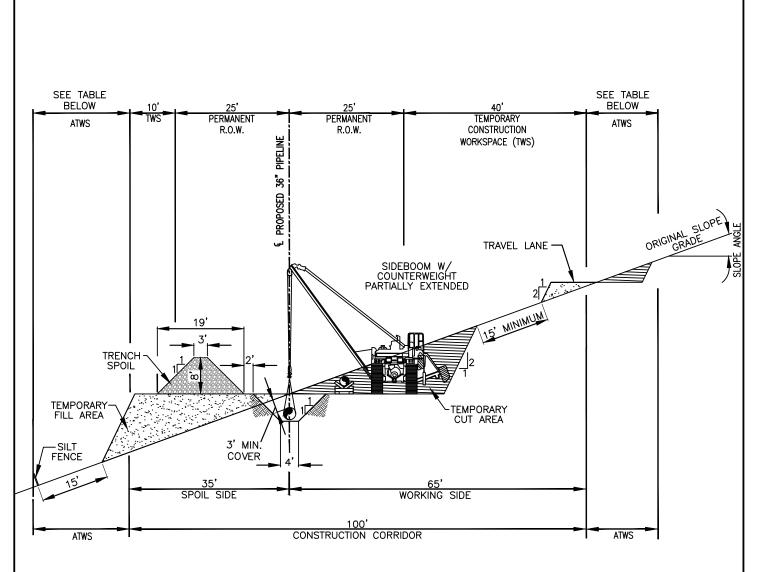


$\frac{\text{TYPICAL CONSTRUCTION CORRIDOR}}{\text{N.T.s.}}$

ADDI	ADDITIONAL TEMPORARY WORKSPACE											
SLOPE ANGLE SPOIL SIDE WORKING SIDE												
0*-10*	15'	15'										
10*-20*	25'											
2030.	25'	50'										

							Sabal Trail	
					DWN. BY: GIE CHK. JC PROJ. ENGR. PROJ. MGR.	4-25-14 5-28-14	SABAL TRAIL TRANSM UPLAND CONSTRUC TYPICAL SIDE CL GREENFIELD SECT	TION JT
0 NO.	ISSUED FOR PERMITTING REVISION DESCRIPTION	GIE BY	11/20/2014 DATE	JW CHK'D	 CLIENT APP. SCALE: AS NO	OTED	FIGURE # 8 DWG. NO. 1657-PL-DG-28208	SHT. NO. REV. 1 OF 1 0



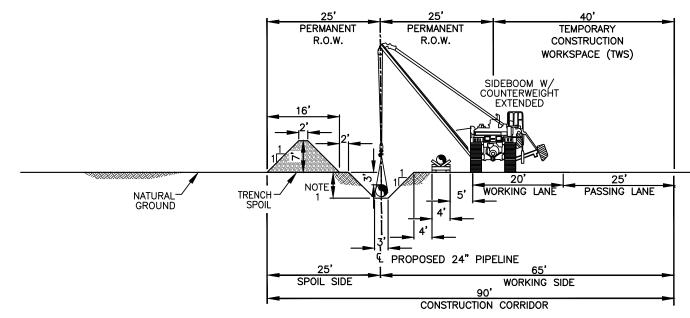

1. MINIMUM TRENCH DEPTH WILL BE 5'-6".


2. THIS CONSTRUCTION METHOD APPLIES TO CITRUS COUNTY LINE LOCATIONS WHERE THE APPLICABLE R.O.W. ARRANGEMENT CALLS FOR 25'/25' PERMANENT R.O.W.

3. THIS CONSTRUCTION METHOD APPLIES TO FORWARD & REVERSE PIPELINE LAY.

TYPICAL CONSTRUCTION CORRIDOR

N.T.S.


								Sabal Trail		
						DWN. BY: NC	4-23-14 05-28-14	LIDLAND CONCEDUO		
						PROJ. MGR.	00 20 14	WITHOUT TOPSO SEGREGATION		
0	ISSUED FOR PERMITTING	NC	11/20/14	JW	JC	CLIENT APP.		FIGURE #9		REV.
NO.	REVISION DESCRIPTION	BY	DATE	CHK'D	APP'D	SCALE: AS NO	TED	1657-PL-DG-28211	1 OF 1	0

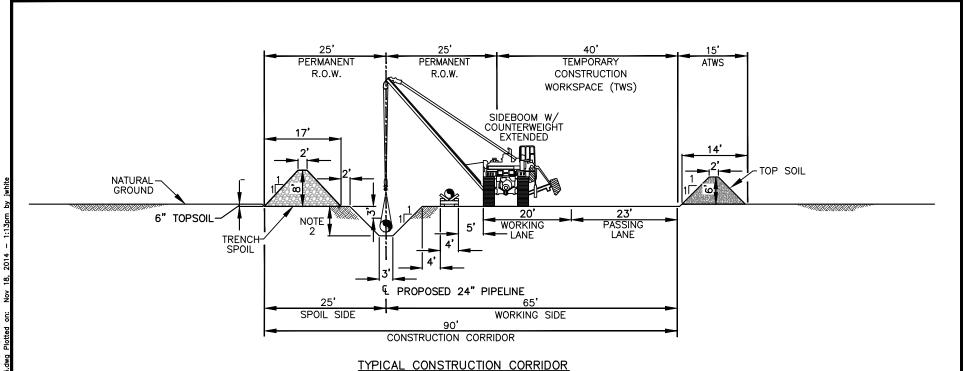

N.T.S.

- UP TO 12" OF TOPSOIL TO BE SEPARATED FOR FULL CONSTRUCTION CORRIDOR WIDTH THROUGHOUT CULTIVATED AND ROTATED CROPLANDS, PASTURE, RESIDENTIAL AREAS.
- 2. MINIMUM TRENCH DEPTH AFTER TOPSOIL IS REMOVED WILL BE 6'-0".
- THIS CONSTRUCTION METHOD APPLIES TO LOCATIONS WHERE THE APPLICABLE R.O.W. ARRANGEMENT CALLS FOR 25'/25' PERMANENT R.O.W. AND TOPSOIL SEPARATION IS NEEDED.
- 4. THIS CONSTRUCTION METHOD APPLIES TO FORWARD & REVERSE PIPELINE LAY.
- 5. FOR ADDITIONAL DETAILS IN REGARDS TO CO-LOCATED UTILITIES REFER TO APPLICABLE R.O.W. ARRANGEMENT.

ı								Sabal Trail
ı							DWN. BY: NC 4-25-	SABAL TRAIL TRANSMISSION
ı							^{СНК.} JC 5-28-	4 UPLAND CONSTRUCTION
ı							PROJ. ENGR.	FULL WIDTH TOPSOIL
1							PROJ. MGR.	SEGREGATION (FL)
ı	0	ISSUED FOR PERMITTING	NC	11/20/14	JW	JC	CLIENT APP.	FIGURE #10
	NO.	REVISION DESCRIPTION	BY	DATE	CHK'D	APP'D	SCALE: AS NOTED	DWG. NO. SHT. NO. REV 1657-PL-DG-28215 1 OF 1 0

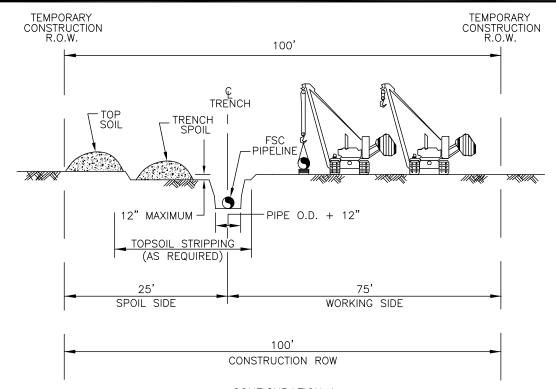

CONFIGURATION 1

PROFILE - LOOKING DOWNSTREAM


PASSING LANE- NORMAL OFFSET

PROFILE

NOTES:

- 1. CONSTRUCTION RIGHT-OF-WAY WILL TYPICALLY BE 100 FEET WIDE CONSISTING OF 50 FEET OF PERMANENT EASEMENT AND 50 FEET OF TEMPORARY WORKSPACE. EXTRA TEMPORARY WORK SPACE WILL BE NECESSARY AT MAJOR ROAD, RAIL AND RIVER CROSSINGS AND OTHER SPECIAL CIRCUMSTANCES, AS REQUIRED. CERTAIN SITUATIONS MAY REQUIRE A NARROWER WIDTH.
- 2. THIS DRAWING REFLECTS "TRENCH AND SPOIL SIDE" TOPSOIL STRIPPING PROCEDURE. SALVAGE TOPSOIL OVER TRENCH AND UNDER THE SPOIL PILE AT LOCATIONS IDENTIFIED ON THE CONSTRUCTION ALIGNMENT SHEETS, OR AS DIRECTED BY THE COMPANY'S INSPECTOR. DEPTH OF TOPSOIL STRIPPING IS NOT TO EXCEED 12 INCHES.
- 3. STOCKPILE TOPSOIL AS SHOWN OR IN ANY CONFIGURATION APPROVED BY THE COMPANY'S ENVIRONMENTAL INSPECTOR. KEEP TOP SOIL CLEAN OF ALL CONSTRUCTION DEBRIS. MAINTAIN A MINIMUM 12 INCHES OF SEPARATION BETWEEN TOPSOIL AND SUBSOIL PILES.
- 4. LEAVE GAPS IN TOPSOIL AND SPOIL PILES AT OBVIOUS DRAINAGES. DO NOT PUSH TOPSOIL INTO CREEKS OR WETLANDS. DO NOT USE TOPSOIL FOR PADDING. AVOID SCALPING VEGETATED GROUND SURFACE WHEN BACKFILLING TOPSOIL PILE.
- 5. TEMPORARILY SUSPEND TOPSOIL HANDLING OPERATIONS DURING INORDINATELY WINDY CONDITIONS UNTIL MITIGATIVE MEASURES TO MINIMIZE WIND EROSION CAN BE IMPLEMENTED.

			Uni	iversalPegasu						CONNECTION.			
									TYPICAL				
	D		ISSUE FO	R USE		07/01/14		LD					
ıl	С	ISSU	E FOR FINAL P	RE-FERC FILIN	G	12/20/13		D	CONSTR	CONSTRUCTION CONFIGURATION 1			
۱ '	В		ISSUED FOR 3	0% DESIGN		10/2	5/13	LD					
	Α		ISSUED FOR	REVIEW		08/2	1/13	LD					
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		SCALE	DATE	DRAWN	CHE	CKED	APPI	ROVED	PROJ. NO.	DRAWING NUMBER	SHEET		
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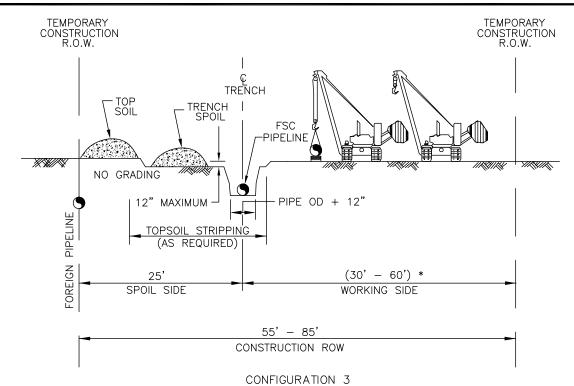


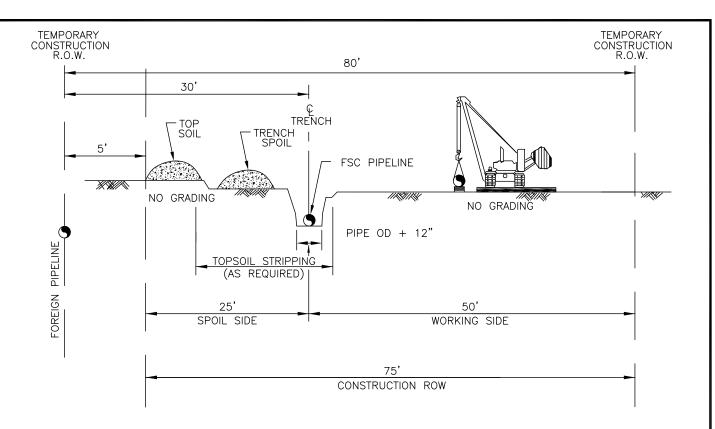FARMED WETLAND CONSTRUCTION-NORMAL OFFSET PROFILE

- 1. FLAG WETLAND BOUNDARIES PRIOR TO CLEARING.
- 2. NO REFUELING OF MOBILE EQUIPMENT IS ALLOWED WITHIN 100 FEET OF WETLAND. PLACE "NO FUELING" SIGN POSTS 100 FEET BACK FROM WETLAND BOUNDARY. REFUEL STATIONARY EQUIPMENT AS PER FSC SPILL PREVENTION PROCEDURES.
- 3. INSTALL TEMPORARY SLOPE BREAKER UPSLOPE WITHIN 100 FEET OF WETLAND BOUNDARY IF ON THE ENVIRONMENTAL PLAN FOR FSC.
- 4. INSTALL TIMBER MATS/RIPRAP THROUGH ENTIRE WETLAND AREA. EQUIPMENT NECESSARY FOR RIGHT-OF-WAY CLEARING MAY MAKE ONE (1) PASS THROUGH THE WETLAND BEFORE MATS ARE INSTALLED.
- 5. AVOID ADJACENT WETLANDS. INSTALL SEDIMENT BARRIERS (STRAW BALES AND/OR SILT FENCE) AT DOWNSLOPE EDGE OF RIGHT-OF-WAY AND ALONG WETLAND EDGE AS REQUIRED.
- 6. RESTRICT ROOT GRUBBING TO ONLY THAT AREA OVER THE DITCHLINE AND DITCH SPOIL AREAS AND REMOVE FROM WETLAND FOR DISPOSAL.
- 7. TOPSOIL STRIPPING SHALL NOT BE REQUIRED IN SATURATED SOIL CONDITIONS.
- 8. LEAVE HARD PLUGS AT EDGE OF WETLAND UNTIL JUST PRIOR TO TRENCHING.
- 9. PIPE SECTION MAY BE FABRICATED WITHIN THE WETLAND AND ADJACENT TO ALIGNMENT, OR IN STAGING AREA OUTSIDE THE WETLAND AND WALKED IN.
- 10. TRENCH THROUGH WETLAND.
- 11. LOWER-IN-PIPE, INSTALL TRENCH PLUGS AT WETLAND EDGES AS REQUIRED AND BACKFILL IMMEDIATELY.
- I2. REMOVE TIMBER MATS OR PREFABRICATED MATS FROM WETLAND UPON COMPLETION.
- 13. RESTORE GRADE TO NEAR PRE—CONSTRUCTION TOPOGRAPHY, REPLACE TOPSOIL, AND INSTALL PERMANENT EROSION CONTROL.

FLOI	RIDA
SOUTHEAST	CONNECTION
PRO.	JECT

			Uni	iversalPegasu						CONNECTION.		
	F		ISSUE FO	R USE		07/0	1/14	LD	TVDICAL			
	Ε	ISSUE	ED FOR FINAL F	PRE-FERC FILIN	1G	12/20/13		LD		TYPICAL		
ıl	D		ISSUED FOR 3	0% DESIGN		10/25/13 10/25/13 09/25/13		LD	CONSTR	CONSTRUCTION CONFIGURATION	RATION 2	
1	С		ISSUED FOR	REVIEW				LD				
- 1	в		ISSUED FOR	REVIEW				LD				
- 1	NO.		REVISI	ON		DA	TE	APPR.				
		SCALE DATE DRAWN CI				CKED	APPI	ROVED	PROJ. NO.	DRAWING NUMBER	SHEET	
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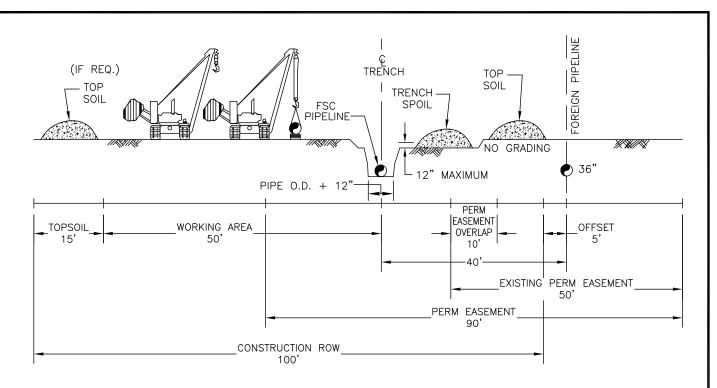
PASSING LANE - NECKDOWN OFFSET - COLLOCATION FOREIGN PIPELINE

PROFILE

NOTES:

- 1. CONSTRUCTION RIGHT—OF—WAY WILL BE NARROWED DOWN TO BETWEEN 55—85 FEET WIDE CONSISTING OF 50 FEET OF PERMANENT EASEMENT AND 5—35 FEET OF TEMPORARY WORKSPACE. EXTRA TEMPORARY WORK SPACE WILL BE NECESSARY AT MAJOR ROAD, RAIL AND RIVER CROSSINGS AND OTHER SPECIAL CIRCUMSTANCES, AS REQUIRED.
- 2. THIS DRAWING REFLECTS "TRENCH AND SPOIL SIDE" TOPSOIL STRIPPING PROCEDURE. SALVAGE TOPSOIL OVER TRENCH AND UNDER THE SPOIL PILE AT LOCATIONS IDENTIFIED ON THE CONSTRUCTION ALIGNMENT SHEETS, OR AS DIRECTED BY THE COMPANY'S INSPECTOR. DEPTH OF TOPSOIL STRIPPING IS NOT TO EXCEED 12 INCHES.
- STOCKPILE TOPSOIL AS SHOWN OR IN ANY CONFIGURATION APPROVED BY THE COMPANY'S ENVIRONMENTAL INSPECTOR. KEEP TOP SOIL CLEAN OF ALL CONSTRUCTION DEBRIS. MAINTAIN A MINIMUM 12 INCHES OF SEPARATION BETWEEN TOPSOIL AND SUBSOIL PILES.
- 4. LEAVE GAPS IN TOPSOIL AND SPOIL PILES AT OBVIOUS DRAINAGES. DO NOT PUSH TOPSOIL INTO CREEKS OR WETLANDS. DO NOT USE TOPSOIL FOR PADDING. AVOID SCALPING VEGETATED GROUND SURFACE WHEN BACKFILLING TOPSOIL PILE.
- 5. TEMPORARILY SUSPEND TOPSOIL HANDLING OPERATIONS DURING INORDINATELY WINDY CONDITIONS UNTIL MITIGATIVE MEASURES TO MINIMIZE WIND EROSION CAN BE IMPLEMENTED.
- * 6. LIMITED BASED ON BOUNDARIES WITH: PROPERTY OWNERS, PROPERTY LINES, FOREIGN PIPELINES, TREE LINES, AND OTHER STRUCTURES.

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			Un	iversalPegasu						CONNECTION.			
	F		ISSUE FO	R USE		07/0	1/14	LD		TYPICAL			
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		N.T.S.	08/21/13	GMM	R	RG		_D	21040	21040-510-TYP-20078	1 OF 1		




CONFIGURATION 4 PROFILE - LOOKING UPSTREAM

PROFILE

- 1. CONSTRUCTION RIGHT—OF—WAY WILL TYPICALLY BE 100 FEET WIDE CONSISTING OF 50 FEET OF PERMANENT EASEMENT AND 50 FEET OF TEMPORARY WORKSPACE. EXTRA TEMPORARY WORK SPACE WILL BE NECESSARY AT MAJOR ROAD, RAIL AND RIVER CROSSINGS AND OTHER SPECIAL CIRCUMSTANCES, AS REQUIRED. CERTAIN SITUATIONS MAY REQUIRE A NARROWER WIDTH.
- 2. THIS DRAWING REFLECTS "TRENCH AND SPOIL SIDE" TOPSOIL STRIPPING PROCEDURE. SALVAGE TOPSOIL OVER TRENCH AND UNDER THE SPOIL PILE AT LOCATIONS IDENTIFIED ON THE CONSTRUCTION ALIGNMENT SHEETS, OR AS DIRECTED BY THE COMPANY'S INSPECTOR. DEPTH OF TOPSOIL STRIPPING IS NOT TO EXCEED 12 INCHES.
- 3. STOCKPILE TOPSOIL AS SHOWN OR IN ANY CONFIGURATION APPROVED BY THE COMPANY'S ENVIRONMENTAL INSPECTOR. KEEP TOP SOIL CLEAN OF ALL CONSTRUCTION DEBRIS. MAINTAIN A MINIMUM 12 INCHES OF SEPARATION BETWEEN TOPSOIL AND SUBSOIL PILES.
- 4. LEAVE GAPS IN TOPSOIL AND SPOIL PILES AT OBVIOUS DRAINAGES. DO NOT PUSH TOPSOIL INTO CREEKS OR WETLANDS. DO NOT USE TOPSOIL FOR PADDING. AVOID SCALPING VEGETATED GROUND SURFACE WHEN BACKFILLING TOPSOIL PILE.
- 5. TEMPORARILY SUSPEND TOPSOIL HANDLING OPERATIONS DURING INORDINATELY WINDY CONDITIONS UNTIL MITIGATIVE MEASURES TO MINIMIZE WIND EROSION CAN BE IMPLEMENTED.

FLORIDA	
SOUTHEAST CONNECTION	Ν
PROJECT	

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	Α		ISSUED FOR	REVIEW		08/2	1/13	LD						
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CONFIGURATION 5

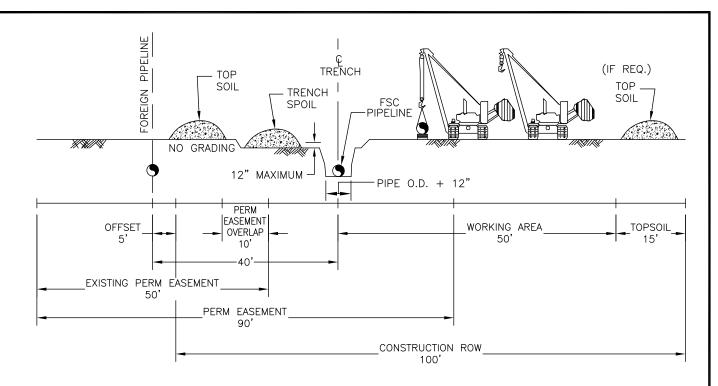
PROFILE - LOOKING/DOWNSTREAM

WORKING LAYOUT CONFIGURATION
PARALLEL FOREIGN PIPELINE OVERLAPPING PERMANENT EASEMENT

NOTES:

- 1. CONSTRUCTION RIGHT—OF—WAY WILL TYPICALLY BE 100 FEET WIDE CONSISTING OF 50 FEET OF PERMANENT EASEMENT AND 50 FEET OF TEMPORARY WORKSPACE. EXTRA TEMPORARY WORK SPACE WILL BE NECESSARY AT MAJOR ROAD, RAIL AND RIVER CROSSINGS AND OTHER SPECIAL CIRCUMSTANCES, AS REQUIRED. CERTAIN SITUATIONS MAY REQUIRE A NARROWER WIDTH.
- 2. THIS DRAWING REFLECTS "TRENCH AND SPOIL SIDE" TOPSOIL STRIPPING PROCEDURE. SALVAGE TOPSOIL OVER TRENCH AND UNDER THE SPOIL PILE AT LOCATIONS IDENTIFIED ON THE CONSTRUCTION ALIGNMENT SHEETS, OR AS DIRECTED BY THE COMPANY'S INSPECTOR. DEPTH OF TOPSOIL STRIPPING IS NOT TO EXCEED 12 INCHES.
- 3. STOCKPILE TOPSOIL AS SHOWN OR IN ANY CONFIGURATION APPROVED BY THE COMPANY'S ENVIRONMENTAL INSPECTOR. KEEP TOP SOIL CLEAN OF ALL CONSTRUCTION DEBRIS. MAINTAIN A MINIMUM 12 INCHES OF SEPARATION BETWEEN TOPSOIL AND SUBSOIL PILES.
- 4. LEAVE GAPS IN TOPSOIL AND SPOIL PILES AT OBVIOUS DRAINAGES. DO NOT PUSH TOPSOIL INTO CREEKS OR WETLANDS. DO NOT USE TOPSOIL FOR PADDING. AVOID SCALPING VEGETATED GROUND SURFACE WHEN BACKFILLING TOPSOIL PILE.
- 5. TEMPORARILY SUSPEND TOPSOIL HANDLING OPERATIONS DURING INORDINATELY WINDY CONDITIONS UNTIL MITIGATIVE MEASURES TO MINIMIZE WIND EROSION CAN BE IMPLEMENTED.

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CONFIGURATION 6

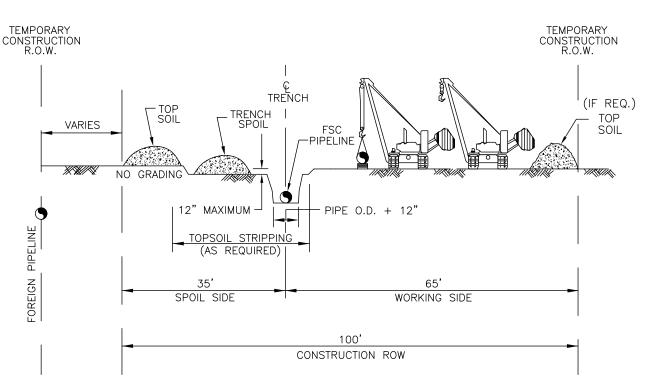WORKING LAYOUT CONFIGURATION PARALLELING


FOREIGN PIPELINE - NO OVERLAPPING PERMANENT EASEMENT/GAS EASEMENT

PROFILE

- 1. CONSTRUCTION RIGHT—OF—WAY WILL TYPICALLY BE 100 FEET WIDE CONSISTING OF 50 FEET OF PERMANENT EASEMENT AND 50 FEET OF TEMPORARY WORKSPACE. EXTRA TEMPORARY WORK SPACE WILL BE NECESSARY AT MAJOR ROAD, RAIL AND RIVER CROSSINGS AND OTHER SPECIAL CIRCUMSTANCES, AS REQUIRED. CERTAIN SITUATIONS MAY REQUIRE A NARROWER WIDTH.
- 2. THIS DRAWING REFLECTS "TRENCH AND SPOIL SIDE" TOPSOIL STRIPPING PROCEDURE. SALVAGE TOPSOIL OVER TRENCH AND UNDER THE SPOIL PILE AT LOCATIONS IDENTIFIED ON THE CONSTRUCTION ALIGNMENT SHEETS, OR AS DIRECTED BY THE COMPANY'S INSPECTOR. DEPTH OF TOPSOIL STRIPPING IS NOT TO EXCEED 12 INCHES.
- 3. STOCKPILE TOPSOIL AS SHOWN OR IN ANY CONFIGURATION APPROVED BY THE COMPANY'S ENVIRONMENTAL INSPECTOR. KEEP TOP SOIL CLEAN OF ALL CONSTRUCTION DEBRIS. MAINTAIN A MINIMUM 12 INCHES OF SEPARATION BETWEEN TOPSOIL AND SUBSOIL PILES.
- 4. LEAVE GAPS IN TOPSOIL AND SPOIL PILES AT OBVIOUS DRAINAGES. DO NOT PUSH TOPSOIL INTO CREEKS OR WETLANDS. DO NOT USE TOPSOIL FOR PADDING. AVOID SCALPING VEGETATED GROUND SURFACE WHEN BACKFILLING TOPSOIL PILE.
- 5. TEMPORARILY SUSPEND TOPSOIL HANDLING OPERATIONS DURING INORDINATELY WINDY CONDITIONS UNTIL MITIGATIVE MEASURES TO MINIMIZE WIND EROSION CAN BE IMPLEMENTED.

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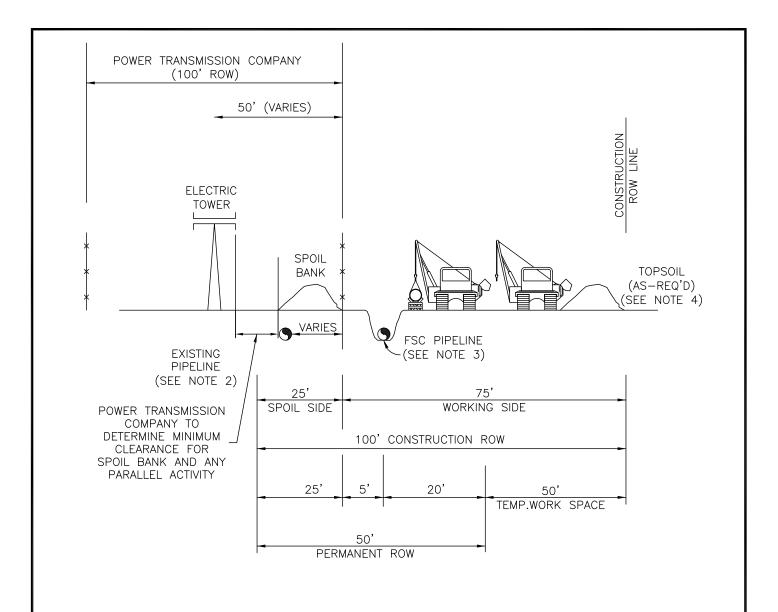
CONFIGURATION 7 PROFILE - LOOKING DOWNSTREAM PASSING LANE- ALTERNATE NORMAL OFFSET

PROFILE

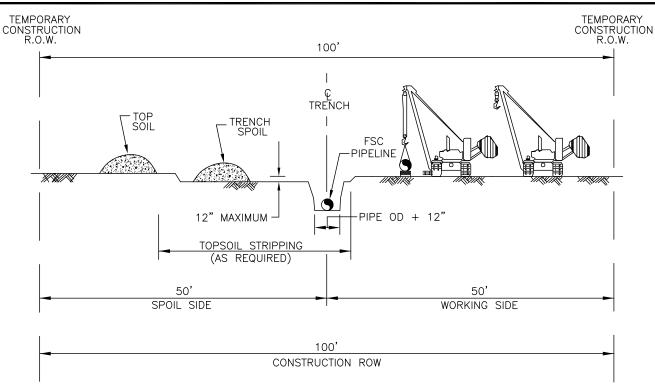NOTES:

- 1. CONSTRUCTION RIGHT-OF-WAY WILL TYPICALLY BE 100 FEET WIDE CONSISTING OF 50 FEET OF PERMANENT EASEMENT AND 50 FEET OF TEMPORARY WORKSPACE. EXTRA TEMPORARY WORK SPACE WILL BE NECESSARY AT MAJOR ROAD, RAIL AND RIVER CROSSINGS AND OTHER SPECIAL CIRCUMSTANCES, AS REQUIRED. CERTAIN SITUATIONS MAY REQUIRE A NARROWER WIDTH.
- 2. THIS DRAWING REFLECTS "TRENCH AND SPOIL SIDE" TOPSOIL STRIPPING PROCEDURE. SALVAGE TOPSOIL OVER TRENCH AND UNDER THE SPOIL PILE AT LOCATIONS IDENTIFIED ON THE CONSTRUCTION ALIGNMENT SHEETS, OR AS DIRECTED BY THE COMPANY'S INSPECTOR. DEPTH OF TOPSOIL STRIPPING IS NOT TO EXCEED 12 INCHES.
- 3. STOCKPILE TOPSOIL AS SHOWN OR IN ANY CONFIGURATION APPROVED BY THE COMPANY'S ENVIRONMENTAL INSPECTOR. KEEP TOP SOIL CLEAN OF ALL CONSTRUCTION DEBRIS. MAINTAIN A MINIMUM 12 INCHES OF SEPARATION BETWEEN TOPSOIL AND SUBSOIL PILES.
- 4. LEAVE GAPS IN TOPSOIL AND SPOIL PILES AT OBVIOUS DRAINAGES. DO NOT PUSH TOPSOIL INTO CREEKS OR WETLANDS. DO NOT USE TOPSOIL FOR PADDING. AVOID SCALPING VEGETATED GROUND SURFACE WHEN BACKFILLING TOPSOIL PILE.
- 5. TEMPORARILY SUSPEND TOPSOIL HANDLING OPERATIONS DURING INORDINATELY WINDY CONDITIONS UNTIL MITIGATIVE MEASURES TO MINIMIZE WIND EROSION CAN BE IMPLEMENTED.

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			Un	iversalPegasu INTERNATION						CONNECTION.			
										TYPICAL			
	D		ISSUE FOR USE					LD					
ıl	O	ISSU	IE FOR FINAL F	RE-FERC FILIN	G	12/20/13		LD	CONSTRUCTION CONFIGURATION 7				
'	В		ISSUED FOR 3	0% DESIGN		10/2	10/25/13 LD						
	Α		ISSUED FOR	REVIEW		09/20/13 LD							
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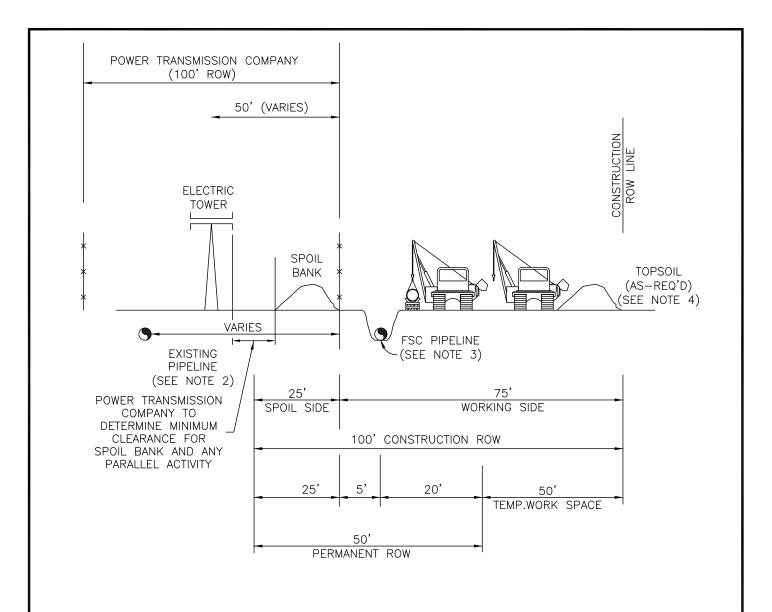
- CONFIGURATION DOES NOT INCLUDE ADDITIONAL TEMPORARY WORK SPACE AT CROSSINGS.
- 2. THE EXISTING PIPELINE LIES MOSTLY WITHIN THE POWER TRANSMISSION COMPANY ROW, BUT DOES SWITCH SIDES WITHIN THE ROW.
- 3. THE PROPOSED PIPE IS LAID MOSTLY ADJACENT TO THE POWER TRANSMISSION COMPANY ROW, BUT DOES SWITCH SIDES WITHIN THE ROW.

4. DIMENSION FROM DESKTOP ANALYSIS. TO BE FIELD VERIFIED.

OPTION - A

FLO	RIDA
SOUTHEAST	CONNECTION
PRO	JECT


			Uni	versalPegasu				FLORIDA SOUTHEAST CONNECTION.				
	I ISSUE FOR USE 07/01/14							LD	100' DICHT OF WAY LAVING			
1	H RE-ISSUED PER FSC EXHIBIT FOR DUKE AGREEMENT						2/14	ΓD		100' RIGHT—OF—WAY LAYING		
1	G	G ISSUE FOR FINAL PRE-FERC FILING					12/20/13		l AC	JACENT TO ELECT	RIC	
	F	ISSUED FOR 30% DESIGN				10/25/13		LD	l TR	RANSMISSION TOWE	RS	
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- 1. CONFIGURATION DOES NOT INCLUDE ADDITIONAL TEMPORARY WORK SPACE AT CROSSINGS.
- 2. THE EXISTING PIPELINE LIES MOSTLY WITHIN THE POWER TRANSMISSION COMPANY ROW, BUT DOES SWITCH SIDES WITHIN THE ROW.
- 3. THE PROPOSED PIPE IS LAID MOSTLY ADJACENT TO THE POWER TRANSMISSION COMPANY ROW, BUT DOES SWITCH SIDES WITHIN THE ROW.
- 4. DIMENSION FROM DESKTOP ANALYSIS. TO BE FIELD VERIFIED.

OPTION - B

			Uni	versalPegasu INTERNATION				CONNECTION.				
	1	I ISSUE FOR USE					1/14	LD	100'	100' RIGHT-OF-WAY LAYING		
Г	H RE-ISSUED PER FSC EXHIBIT FOR DUKE AGREEMENT						2/14	LD				
Γ	G ISSUE FOR FINAL PRE-FERC FILING					12/20/13 LD		ADJACENT TO ELECTRIC				
	F	ISSUED FOR 30% DESIGN				10/25	5/13	LD	l TR	RANSMISSION TOWE	RS	
	E		ISSUED FOR	REVIEW		10/25/13		LD		& POLFS		
Ν	10.	D. REVISION				DATE		APPR.		& FULES		
L	S	CALE	DATE	DRAWN	CHE	CKED	APPI	ROVED	PROJ. NO.	DRAWING NUMBER	SHEET	
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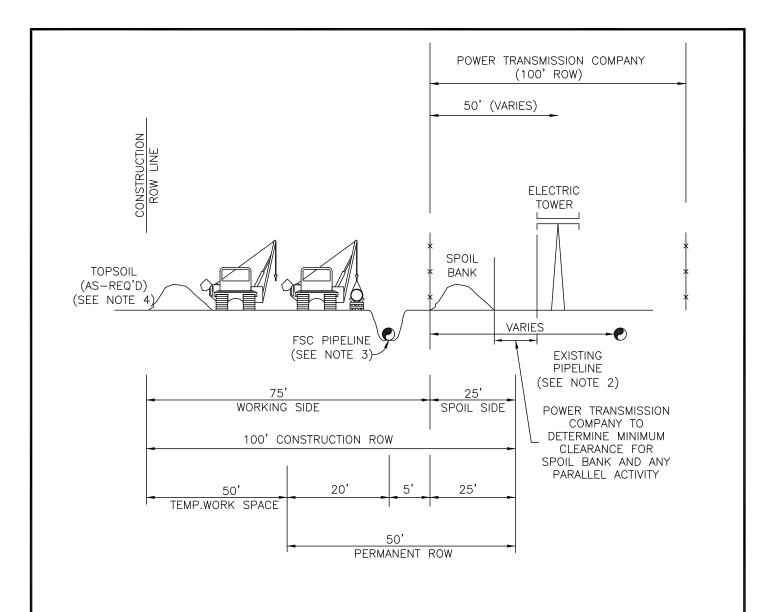


- 1. CONFIGURATION DOES NOT INCLUDE ADDITIONAL TEMPORARY WORK SPACE AT CROSSINGS.
- 2. THE EXISTING PIPELINE LIES MOSTLY WITHIN THE POWER TRANSMISSION COMPANY ROW, BUT DOES SWITCH SIDES WITHIN THE ROW.
- 3. THE PROPOSED PIPE IS LAID MOSTLY ADJACENT TO THE POWER TRANSMISSION COMPANY ROW, BUT DOES SWITCH SIDES WITHIN THE ROW.

4. DIMENSION FROM DESKTOP ANALYSIS. TO BE FIELD VERIFIED.

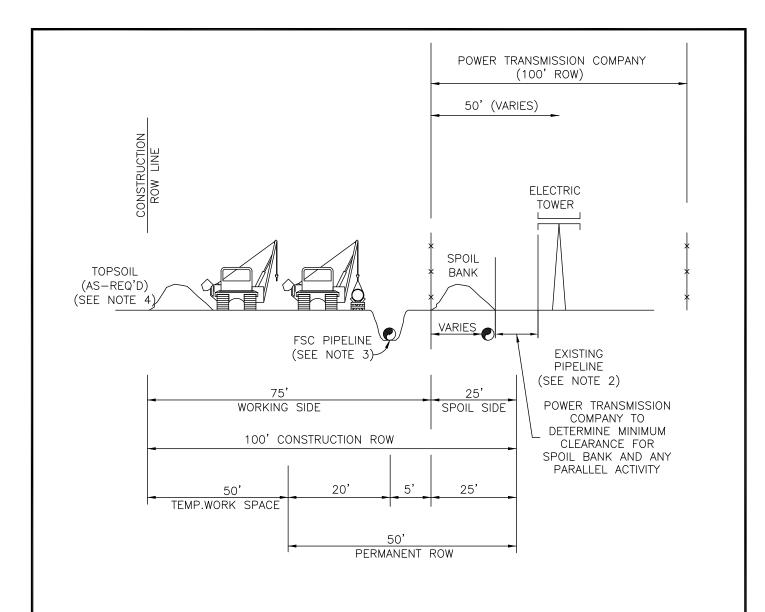OPTION - C

		Un	iversalPegasu				FLORIDA SOUTHEAST CONNECTION.					
	I ISSUE FOR USE					1/14	LD	100'	100' DICHT OF WAY LAYING			
ŀ	H RE-ISSUED PER FSC EXHIBIT FOR DUKE AGREEMENT					06/02/14 LI			100' RIGHT-OF-WAY LAYING			
	ISSUE FOR FINAL PRE-FERC FILING				12/20/13		LD	AD	ADJACENT TO ELECTRIC			
F	•	ISSUED FOR 3	0% DESIGN		10/25/1		LD	l tr	RANSMISSION TOWE	RS		
F	:	ISSUED FOR	REVIEW		10/2	5/13	LD		& POLFS	., .0		
N	Э.	. REVISION		DA		TE	APPR.		& PULES			
	SCALE	SCALE DATE DRAWN CHE		CHE	CKED	APP	ROVED	PROJ. NO.	DRAWING NUMBER	SHEET		
	N.T.S.	07/09/13	LB	R	rG		LD	21040	21040-510-TYP-20038	3 OF 5		




- CONFIGURATION DOES NOT INCLUDE ADDITIONAL TEMPORARY WORK SPACE AT CROSSINGS.
- 2. THE EXISTING PIPELINE LIES MOSTLY WITHIN THE POWER TRANSMISSION COMPANY ROW, BUT DOES SWITCH SIDES WITHIN THE ROW.
- 3. THE PROPOSED PIPE IS LAID MOSTLY ADJACENT TO THE POWER TRANSMISSION COMPANY ROW, BUT DOES SWITCH SIDES WITHIN THE ROW.
- 4. DIMENSION FROM DESKTOP ANALYSIS. TO BE FIELD VERIFIED.

OPTION - D

FLO	RIDA
SOUTHEAST	CONNECTION
PRO	JECT

		Un	iversalPegasu				FLORIDA SOUTHEAST CONNECTION.					
	I ISSUE FOR USE					1/14	LD	100'	100' DIOLIT OF WAY LAVING			
Н	H RE-ISSUED PER FSC EXHIBIT FOR DUKE AGREEMENT					2/14	LD		100' RIGHT—OF—WAY LAYING			
G	ISSUE FOR FINAL PRE-FERC FILING				12/20/13		LD	AD	ADJACENT TO ELECTRIC			
F		ISSUED FOR 3	0% DESIGN		10/25/1		LD	l tr	RANSMISSION TOWE	RS		
Ε		ISSUED FOR	REVIEW		10/2	5/13	LD		& POLFS			
NO	REVISION				DATE		APPR.		& PULES			
	SCALE	DATE	DRAWN CHE		CKED	APP	ROVED	PROJ. NO.	DRAWING NUMBER	SHEET		
	N.T.S.	07/09/13	LB	F	≀G		LD	21040	21040-510-TYP-20038	4 OF 5		

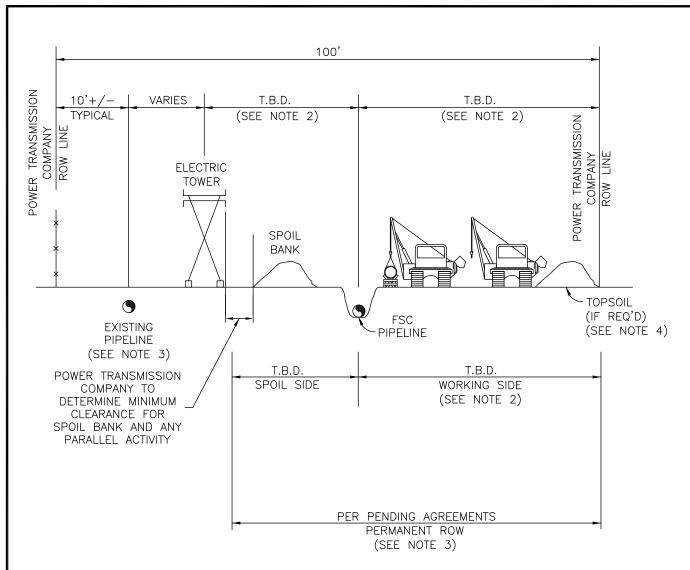

- CONFIGURATION DOES NOT INCLUDE ADDITIONAL TEMPORARY WORK SPACE AT CROSSINGS.
- 2. DUE TO RESTRICTIONS NEAR THE POWER LINE, A PORTION OF THE PIPELINE WILL NEED TO BE LAID WITHIN THE POWER TRANSMISSION COMPANY ROW. THE ACTUAL LOCATION TO BE DETERMINED BY AGREEMENTS. DEPENDING ON PLACEMENT OF THE PIPELINE IN THE POWER LINE ROW, ADDITIONAL PERMANENT AND/OR TEMPORARY ROW MAY BE NEEDED OUTSIDE OF THE POWER LINE ROW FOR THE PIPELINE.
- 3. AT LOCATIONS WHERE THE PROPOSED PIPELINE IS IN THE POWER TRANSMISSION COMPANY ROW, THE EXISTING PIPELINE IS LOCATED ON THE OPPOSITE SIDE OF THE TOWER.

4. TOPSOIL STRIPPING REQUIREMENTS WILL VARY BY LOCATION, SEE DRAWING 21040-510-TYP-20041 FOR TOPSOIL STRIPPING METHODS.

OPTION - E

			Un	iversalPegasu					CONNECTION.			
	G	G ISSUE FOR USE					1/14	LD	100'	RIGHT-OF-WAY I	AVINIC	
	F RE-ISSUED PER FSC EXHIBIT FOR DUKE AGREEMENT					06/0	06/02/14 LD					
	Ε	ISSUE FOR FINAL PRE-FERC FILING				12/20/13		LD	AD	ADJACENT TO ELECTRIC		
	D		ISSUED FOR 3	0% DESIGN		10/2	5/13	LD	l tr	RANSMISSION TOWE	RS	
- [С		ISSUED FOR	REVIEW		10/2	5/13	LD	& POLES			
-	NO.	REVISION			DATE		APPR.		& PULES			
		SCALE	DATE	DRAWN	CHE	CKED	APPI	ROVED	PROJ. NO.	DRAWING NUMBER	SHEET	
		N.T.S.	08/21/13	LB	F	≀G		LD	21040	21040-510-TYP-20038	5 OF 5	